

May 26, 2017

School Board of Brevard County 2700 Judge Fran Jamieson Way Viera, FL 32940-6699

Attn: Dane Theodore

HCI Project 1704601003 PO# SBBC DB Eau Gallie Aircraft Maintenance Classroom Concept 3

Subject: Pre-Construction Design/Build Services Proposal for Eau Gallie HS Aviation Lab

At your request we are providing our proposal for subject services which will develop the architectural & engineering drawings required to develop a project scope of work and GMP for your Eau Gallie High School Aviation Lab Addition. The design and construction of a new 7500 sf, single story, free standing, pre-engineered metal building in the area currently used for parking. This concept will include a new aviation classroom, office and restrooms within the new enclosed space. The finishes will include a continuous standing seem metal roof with Kynar color finish and steel insulated wall panels. All work will be subject to terms and conditions as stipulated in the Continuing Contract for Design Build Services between Heard Construction Inc. and the School Board of Brevard County.

HCI/TSARK Architecture proposes to provide Pre-construction Design/Build Services in the amount of \$79,252.64. We have enclosed our Project Estimate of Pre-Construction Design/Build costs and TSARK's Proposal dated 5/3/17.

This work will begin on receipt of your "Notice to Proceed" and will be completed per the following schedule:

BPS Board Approval of Pre-construction D/B Services 6/13/17
Receipt of Notice To Proceed (NTP) 6/14/17
30% Construction Drawings 7/7/28/17
60% Construction Drawings 7/21/17
90% Construction Drawings 8/11/17
Final Construction Documents 8/18/17
Bidding Phase 8/10/17 thru 8/31/17
Final GMP submitted for BPS Board Approval 9/8/17
BPS Board Approval 10/10/17
Receipt of Notice To Proceed (NTP) with Construction 10/11/17
Permitting 10/11/17 thru 11/10/17
Start of Construction 11/13/17
Substantial Completion 7/31/18

EXCLUSIONS AND CLARIFICATIONS

1. A&E construction administration fees are excluded and will be included in the GMP.

We thank you for this opportunity and look forward to working with you on the project.

Sincerely,

Sam Heard

Heard Construction, Inc.

Sam Heard



Project No 1704601010

SBBC DB Eau Gallie Aircraft Maintenance Classroom

Item Description Estimate Type: Bu		Status: Submitted Unit	Unit Price	Extended Amoun
CSI Division 0 - General Conditions				
Principal	20	hrs	93.42	1,868.4
Pre-construction Project Manager	60	hrs	91.91	5,514.6
Estimator	80	hrs	41.85	3,348.0
Administrator Assistant	8	hrs	43.55	348.4
Architectural Design Services	1	ls	53,010.00	53,010.0
Utility Locates	1	allowance	1,600.00	1,600.0
Surveyor	1	allowance	2,500.00	2,500.0
Reproduction and printing	1	allowance	1,000.00	1,000.0
Geotech Allowance	1	allowance	2,500.00	2,500.0
	CSI Divisior	n 0 - General C	onditions Total	71,689.4
			Subtotal	71,689.4
lotes		Estimated	Cost Subtotal	71,689.4
		General Lial	oility @ 0.30%	215.0
	Р	rofessional Lial		<u>143.3</u>
			Subtotal	72,047.8
		Overh	nead @ 0.00% Subtotal	<u>0.0</u> 72,047.3
		E	Subtotal Fee @ 10.00%	72,047.5 <u>7,204.</u>
		•	Subtotal	79,252.
			Contingency	0.0
		Pre-const	ruction/Design	<u>0.</u>
			Subtotal	79,252.
		E	Bond @ 0.00%	0.0
			Total	79,252.



May 3, 2017

Mr. Harry Earl Heard Construction, Inc. P.O. Box 540218 Merritt Island, FL 32954

Re: CTE Lab/Aircraft Maintenance Building

Dear Harry,

Thank you for considering TSARK ARCHITECTURE for the design of a new Career Technical Education Classroom and Laboratory for an Aircraft Maintenance Program at Eau Gallie High School. We understand the program consists of approximately 7,500 sq. ft. of enclosed new space in a single story pre-engineered metal building. Our proposed scope includes full architecture and engineering services from programming through construction administration.

The consultants comprising the Design Team will be as follows:

- Architecture: Tsark Architecture, LLC

Civil Engineering: Construction Engineering Group
 Structural Engineering: Construction Engineering Group
 MEP and Fire Protection: Construction Engineering Group

We understand this will be a Design-Build project delivery and that your firm will be the General Contractor.

Scope of Services:

TSARK ARCHITECTURE will conduct the following services, consulting with the Owner and General Contractor, researching applicable design criteria, attending Project meetings, communicating with members of the Project team and reporting progress to the Owner and Construction Manager.

Schematic Design Phase Services

- Review laws, codes, and regulations applicable to the project.
- Conduct a site investigation and collect as-built information.

- Further develop the preliminary design (attached) for approval, illustrating the scale and relationship of the project components.
- Consider the benefits of various building systems and equipment in developing a design that is consistent with the established program, schedule, and budget.

Design Development Phase Services

Prepare Design Development documents for approval, consisting of drawings
and other documents including plans, sections, elevations, typical construction
details, and diagrammatic layouts of building systems to fix and describe the size
and character of the project. These documents will identify major materials and
systems and establish in general their quality levels.

Construction Document Phase Services

- Prepare Construction Documents based on the approval of the Design
 Development documents and any needed adjustments in project requirements.
 These documents will consist of drawings and specifications detailing the quality
 levels of materials and systems and other requirements for construction.
- Incorporate into the Construction Documents the design requirements and permitting comments of governing authorities.

Construction Phase Services

- Conduct inspections at appropriate intervals to review conformance of the work with the Contract Documents.
- Reject non-conforming work.
- Review and take appropriate action on contractor submittals.
- Determine the date of Substantial Completion and issue a Certificate of Substantial Completion.
- Following project occupancy, conduct a meeting with the Owner to review the facility operations and performance.

Compensation:

Schematic Design: \$8,835.00
Design Development: \$20,615.00
Construction Documents: \$23,560.00
Construction Administration: \$5,890.00
Total: \$58,900.00

The following services are not included in the above scope:

- Cost estimating
- LEED certification
- Surveying or Geotechnical investigation

Billing for this project will occur upon the completion of each phase listed above.

Schedule:

This work will begin on receipt of your "Notice to Proceed" and will be completed per the following schedule time frames:

BPS Board Approval of Pre-construction D/	B Services: 5/23/17
**	5/24/17
Receipt of Notice To Proceed (NTP):	
30% Construction Drawings (Schematic Desi	ign): 6/7/17
60% Construction Drawings (Design Develo	pment): 6/21/17
90% Construction Drawings:	7/11/17
Final Construction Documents:	7/18/17
Bidding Phase:	3 weeks
Final GMP submitted for BPS Board Approv	val: 8/9/17
BPS Board Approval:	TBD
Receipt of Notice To Proceed (NTP):	TBD
P.O. Issued:	TBD
Start of Construction:	10 weeks to substantial completion
Substantial Completion:	TBD

90 days from substantial Final Completion:

Thank you again, for your consideration, and I look forward to working with you.

Sincerely,

Gregory I. Tsark, AIA, LEED-AP

Gran I Joule

Please sign and date below for acceptance of this proposal and letter agreement. Please also review our attached Terms and Conditions sheet.

Mr. Harry Earl, Vice President Heard Construction, Inc.

Date

Terms and Conditions of the Professional Services Agreement Between Tsark Architecture, LLC and the Owner/Client

ARTICLE 1 ARCHITECT'S RESPONSIBILITIES

The Architect's responsibilities are as described in the attached proposal.

ARTICLE 2 OWNER'S RESPONSIBILITIES

The Owner shall provide full information about the objectives, schedule, constraints and existing conditions of the project, and shall establish a budget with reasonable contingencies that meets the project requirements. The Owner shall furnish surveying, geotechnical engineering and environmental testing services upon request by the Architect. The Owner shall employ a contractor to perform the construction Work and to provide cost estimating services. The Owner shall furnish for the benefit of the project all legal, accounting and insurance counseling services.

ARTICLE 3 USE OF ARCHITECT'S DOCUMENTS

Documents prepared by the Architect are instruments of service for use solely with respect to this project. The Architect shall retain all common law, statutory and other reserved rights, including the copyright. The Owner shall not reuse or permit the reuse of the Architect's documents except by mutual agreement in writing.

ARTICLE 4 TERMINATION, SUSPENSION OR ABANDONMENT

In the event of termination, suspension or abandonment of the project, the Architect shall be equitably compensated for services performed. Failure of the Owner to make payments to the Architect in accordance with this Agreement shall be considered substantial nonperformance and is sufficient cause for the Architect to either suspend or terminate services. Either the Architect or the Owner may terminate the Agreement after giving no less than seven days' written notice in the other party substantially fails to perform in accordance with the terms of this Agreement.

ARTICLE 5 MISCELLANEOUS PROVISIONS

- 5.1 This Agreement shall be governed by the law of the location of the project.
- 5.2 Terms in this Agreement shall have the same meaning as those in AIA Document A205, General Conditions of the Contract for Construction of a Small Project, current as of the date of this Agreement.
- 5.3 The Owner and Architect, respectively, bind themselves, their partners, successors, assigns and legal representatives to this Agreement. Neither party to this Agreement shall assign the contract as a whole without written consent of the other.
- 5.4 The Architect and Architect's consultants shall have no responsibility for the identification, discovery, presence, handling, removal or disposal of, or exposure of persons to, hazardous materials in any form at the project site.

ARTICLE 6 PAYMENTS AND COMPENSATION TO THE ARCHITECT

The Owner shall compensate the Architect as follows.

- 6.1 The Architect's Compensation shall be as described in the attached proposal
- 6.2 The Architect shall be reimbursed for expenses incurred in the interest of the project, plus an administrative fee of <u>Ten</u> percent (10%).
- 6.3 If through no fault of the Architect the services covered by this Agreement have not been completed within <u>Fighteen</u> (18) months of the date hereof, compensation for the Architect's services beyond that time shall be appropriately adjusted.
- 6.4 Payments are due and payable upon receipt of the Architect's invoice. Amounts unpaid <u>Thirty</u> days after invoice date shall bear interest from the date payment is due at the rate of <u>1.5%</u> monthly, at the sole election of the Architect.
- 6.5 Architectural Services not covered by this Agreement include, among others, revisions due to changes in the scope, quality or budget. The Architect shall be paid additional fees for these services based on the Architect's hourly rates when the services are performed.
- 6.6 This Agreement entered into as of the day and year signed in the attached proposal.

Tsark Architecture, LLC Additional Services Rates

Revised September 9, 2016

ADDITIONAL SERVICES

Architectural Services not covered by this Agreement include, among others, revisions due to changes in the scope, quality or budget. The Architect shall be paid additional fees for these services based on the Architect's hourly rates when the services are performed, including:

- 1. Construction site visits or attendance at design review meetings as requested by the Owner in excess of site visits per discipline as defined in the Agreement.
- Value Engineering meetings and subsequent architecture and engineering or design revisions to incorporate extensive
 accepted value engineering items.
- 3. Significant revisions to the program after Schematic Design approval, and significant changes to the systems after Design Development approval.
- 4. Document reproduction beyond those required for coordination and submittals as outlined in the Agreement
- 5. Detailed cost estimating services.

HOURLY RATES

POSITION	HOURLY RATE
Principal	\$140.00
Architect	\$125.00
Project Manager	\$105.00
Designer	\$85.00
Admin/Word Processing	\$45.00

REIMBURSIBLE EXPENSES

Printing

- 24 x 36 or larger, bond: \$1.00/sheet

- Photo/Glossy printing: \$10.00/sq. ft., 3 ft. minimum

- Presentation board and mounting: \$20.00/board

HEARD CONSTRUCTION, INC.

P.O. Box 540218 • Merritt Island, Florida 32954-0218

- (321) 452-5494 • FAX: (321) 452-6946

www.heardconstruction.com

May 3, 2017

School Board of Brevard County 2700 Judge Fran Jamieson Way Viera, FL 32940-6699

Attn: Dane Theodore

Subject: Concept Development, Estimated Costs and Recommendations for Eau Gallie HS Aviation

Lab

We have completed the Concepts Development for a new Eau Gallie High School Aviation Lab Addition. In addition, we have developed preliminary pricing based on the four (4) Concept Designs provided by Tsark Architecture. A brief description and pricing summary for each Concept is as follows:

CONCEPT 1

Construction of a new 4,000 sf enclosed addition to a single story educational building (Building 46) in the open maintenance area to create a new aviation lab. Renovation and remodeling of the existing weight room in building 46 into a new aviation classroom. This Concept requires a 2 hour fire rated wall to separate the new lab area from the existing facility.

Preliminary pricing for Concept #1 is approximately \$720,000.00. A detailed Cost Summary is attached for your review.

CONCEPT 2

This Concept is identical to Concept #1 except a pre-engineered aluminum canopy is being substituted for a steel pre-engineered metal building canopy. This Concept also requires a 2 hour fire rated separation.

Preliminary pricing for Concept #2 is approximately \$741,000.00. A detailed Cost Summary is attached for your review.

CONCEPT 3

Construction of a new 7500 sf, single story, free standing, pre-engineered metal building in the area currently used for parking. This Concept includes the new aviation classroom, office and restroom within the new enclosed space. The finishes include a continuous standing seem metal roof with Kynar color finish and steel insulated wall panels.

Preliminary pricing for Concept #3 is approximately \$814,800.00. A detailed Cost Summary is attached for your review.

CONCEPT 4

Construction of a new 7500 sf, single story, free standing, open pavilion, pre-engineered metal building in the area currently used for parking. This Concept also requires the renovation of the existing weight room in Building 46 into a new aviation classroom. The finishes include a continuous standing seem metal roof with Kynar color finish with wall panels along the upper portion of the structure. This Concept is open and utilizes chain link fencing and gates to secure the perimeter of the structure.

Preliminary pricing for Concept #4 is approximately \$639,400.00

Please note the following:

- 1. The Concept that can be completed with minimal disruption to school operations is Concept #3. This Concept also has the shortest construction completion schedule, ten (10) weeks and can be competed with school in session.
- 2. All Concepts require a 12 to 14 week delivery time for the pre-engineered metal (aluminum or steel) building components.
- 3. Concepts 1 and 2 will require additional overtime/premium costs in the range of \$60,000.00 to \$70,000.00 to complete the work without interruption to school activities. The completion time schedule for these Concepts is double Concept #3 since much of the work will be performed during off hours and there will be additional General Conditions cost due to the extended time frame. Concept 4 will also require some additional overtime/premium costs though not as much as Concepts 1 and 2 since it is not as disruptive.
- 4. Concept 3 incorporates the entire Aviation Education program within one new facility with little or no disruption to other school programs.

Conclusions

1. Concepts 1 and 2 will require 2 to 3 months longer to complete. These Concepts will also be more disruptive to campus operations. These Concepts will require fire rating of existing walls. These Concepts have narrow chain link entry gates in lieu of hangar doors (due to space limitations) requiring removal of the wings of the airplanes to move them in and out. These Concepts will repurpose existing space that is currently being utilized by the sports program. The Concepts are also more subject to existing conditions creating additional construction costs. When the additional costs associated with potential existing condition issues and performing work outside normal hours is taken into consideration, these Concepts could be as or more expensive than Concept 3. We consider these Concepts to be the least attractive.

- 2. Concept 3 will be completed with minimal disruption to campus activities and can be complete by January 2018 with a late May (Pre-Construction Design-Build Services) Notice to Proceed. This concept provides the best learning environment since the aviation lab and classroom (including teacher office and restrooms) are all under one roof. In addition, this Concept does expose the lab to the elements; instruction can take place during inclement weather since this Concept is completely enclosed with insulated wall panels. This Concept is the most desirable if funding is available.
- 3. Concept 4 will also repurpose existing space that is currently being utilized by the sports program. The biggest drawback to this Concept is it is exposed to blowing rain and wind, exposing tools and equipment to the elements. While it is secured with a chain link fence, theft is more likely due to ease of access and visibility of the tools and equipment. This Concept is the second best option if funds are not available for Concept #3. In addition, this Concept is the least expensive.

We thank you for this opportunity and look forward to working with you on the project.

Sincerely,

Harry Earl

Heard Construction, Inc.



Project No 1704601001

SBBC DB Eau Gallie Aircraft Maintenance Classroom Concept 1

Estimate Status: Preliminary Estimate Type: Budget Unit Price Extended Amount **Item Description** Qty Unit CSI Division 0 - General Conditions 174 hrs 63.19 10,995.06 Project Manager (PM) PM Vehicle 1 months 800.00 800.00 PM Phone months 70.00 70.00 400 hrs 53.19 21,276.00 Superintendent 800.00 2,000.00 Superintendent Vehicle 2.5 months 2.5 months 70.00 175.00 Superintendent Phone 1,000.00 Reproduction and printing allowance 1,000.00 450.00 1,800.00 Dumpster each allowance 3,500.00 3,500.00 Daily and final cleanup 2,500.00 Protection of surrounding facilities allowance 2,500.00 1,800.00 Temporary fencing allowance 1,800.00 CSI Division 0 - General Conditions Total 45,916.06 CSI Division 1 - General Requirements 2,500.00 2,500.00 Engineering & testing allowance 1,600.00 1,600.00 1 allowance **Utility Locaates** CSI Division 1 - General Requirements Total 4,100.00 CSI Division 2 - Existing Conditions **Demolition Subcontractor** 1 allowance 1,600.00 1,600.00 Remove existing chain link fencing 6,500.00 **Demolition Subcontractor** 1 allowance 6,500.00 Remove existing CMU walls 10,000.00 10,000.00 **Demolition Subcontractor** allowance Clearing & removal of asphalt paving 1 allowance 1,800.00 1,800.00 **Demolition Subcontractor** Remove wall beneath new roof area CSI Division 2 - Existing Conditions Total 19,900.00 CSI Division 3 - Concrete Cast-in-Place Concrete Subcontractor 1 allowance 36,000.00 36,000.00

6" S.O.G. 3'x3' thickened edge

Item Description	Qty	Unit	Unit Price	Extended Amount
	C	SI Division 3 -	36,000.00	
CSI Division 4 - Masonry				
Unit Masonry Subcontractor Knee wall @ aviation lab	200	lf	60.00	12,000.00
Unit Masonry Subcontractor 200 lf knee wall	1	allowance	12,000.00	12,000.00
	C	CSI Division 4 -	Masonry Total	24,000.00
CSI Division 5 - Metals				
Pre-engineered metal building 4000 sf	1	allowance	85,000.00	85,000.00
Metal building erection Erection between existing buildings	4000	sf	9.00	36,000.00
Metal framing and roofing New roof area shown on concept #1	840	sf	38.00	31,920.00
		CSI Division 5	5 - Metals Total	152,920.00
CSI Division 8 - Openings				
Doors, Frames and Hardware Subcontractor New pair 3'0x7'0 doors to aviation lab	1	allowance	4,800.00	4,800.00
Doors, Frames and Hardware Subcontractor New 3'0"x7'0" doors at aviation lab	2	each	1,600.00	3,200.00
Doors, Frames and Hardware Subcontractor				
	C	SI Division 8 - 0	8,000.00	
CSI Division 9 - Finishes				
Plaster and Gypsum Board Subcontractor 2 hr rated walls allowance	136	lf	175.00	23,800.00
Flooring Subcontractor New VCT flooring	2380	sf	3.00	7,140.00
Flooring Subcontractor	250	If	2.75	687.50
Ceilings Subcontractor	2380	sf	2.50	5,950.00
Floor Coatings Sealed concrete aviation lab floor	4000	sf	0.60	2,400.00
Painting and Coatings Subcontractor New paint Classroom , Office & rated walls	4000	sf	1.50	6,000.00
	C	CSI Division 9 -	45,977.50	
CSI Division 11 - Equipment				
Equipment High volume ceiling fan for Aviation Lab (included in electrical)	1	0	0.00	0.00
	CSI	Division 11 - E	0.00	

Item Description	Qty	Unit	Unit Price	Extended Amount
CSI Division 22 - Plumbing				
Plumbing Subcontractor New eye wash and emergency shower	1	allowance	2,500.00	2,500.00
Plumbing Subcontractor New utility sink	1	allowance	2,000.00	2,000.00
Plumbing Subcontractor Parts washing with contaminated waste	1	allowance	5,000.00	5,000.00
	CS	l Division 22 -	Plumbing Total	9,500.00
CSI Division 23 - HVAC				
HVAC Subcontractor Exhaust fan in welding area	1	allowance	2,500.00	2,500.00
HVAC Subcontractor HVAC Classroom and ductwork mods	1	allowance	5,500.00	5,500.00
		CSI Division 2	23 - HVAC Total	8,000.00
CSI Division 26 - Electrical				
Electrical Subcontractor 600A Service and All power, Fire Alarm, Lighting, Data, Intercom and	1 B/A fan	allowance	180,000.00	180,000.00
Electrical Subcontractor 4 Floor boxes @ Aviation Lab (included in above)	1	0		0.00
Electrical Subcontractor Power outlets for specialized equipment listing (included in above)	1	0		0.00
	CS	l Division 26 -	Electrical Total	180,000.00
CSI Division 32 - Exterior Improvements				
Fences and Gates Swing gates at hangar entry	1	allowance	8,000.00	8,000.00
CSI Divisio	on 32 -	Exterior Impr	ovements Total	8,000.00
CSI Division 33 - Utilities				
Utilities Subcontractor Site drainage mods	1	allowance	15,000.00	15,000.00
Utilities Subcontractor Site utilities allowance	1	allowance	10,000.00	10,000.00
	С	SI Division 33	3 - Utilities Total	25,000.00
			Subtotal	567,313.56
Notes	P	General Lia rofessional Lia	d Cost Subtotal ability @ 0.30% ability @ 0.20% Subtotal rhead @ 0.00%	567,313.56 1,701.94 <u>1,134.63</u> 570,150.13 <u>0.00</u>
			Subtotal Fee @ 10.00%	570,150.13 57,015.01

Item Description	Qty	Unit Unit Price	Extended Amount
		Subtotal	627,165.14
		Contingency	50,000.00
		Pre-construction/Design	<u>43,000.00</u>
		Subtotal	720,165.14
		Bond @ 0.00%	<u>0.00</u>
		Total	720,165.14



Project No 1704601002

SBBC DB Eau Gallie Aircraft Maintenance Classroom Concept 2 Estimate Type: Budget Estimate Status: Preliminary

Item Description	Estimate Type. Buddet		Unit	Unit Price	Extended Amount
CSI Division 0 - General Condition	ons .				
Project Manager (PM)		174	hrs	63.19	10,995.06
PM Vehicle		1	months	800.00	800.00
PM Phone		1	months	70.00	70.00
Superintendent		400	hrs	53.19	21,276.00
Superintendent Vehicle		2.5	months	800.00	2,000.00
Superintendent Phone		2.5	months	70.00	175.00
Reproduction and Printing		1	allowance	1,000.00	1,000.00
Dumpster		4	each	450.00	1,800.00
Daily and final clean up		1	allowance	3,500.00	3,500.00
Protection of surrounding facilitie	s	1	allowance	2,500.00	2,500.00
Temporary fencing		1	allowance	1,800.00	1,800.00
	9	CSI Division	0 - General Co	onditions Total	45,916.06
CSI Division 1 - General Require	<u>ments</u>				
Engineering & Testing		1	allowance	2,500.00	2,500.00
Utility Locates		1	allowance	1,600.00	1,600.00
	CSI	Division 1 -	General Requi	rements Total	4,100.00
CSI Division 2 - Existing Condition	o <u>ns</u>				
Demolition Subcontractor Remove existing chain link fencing		1	allowance	1,800.00	1,800.00
Demolition Subcontractor Remove existing CMU walls		1	allowance	6,500.00	6,500.00
Demolition Subcontractor Clearing and removal of existing asp	nalt paving	1	allowance	10,000.00	10,000.00
Demolition Subcontractor Remove wall Room 104		1	allowance	1,800.00	1,800.00
		CSI Division	2 - Existing Co	onditions Total	20,100.00
CSI Division 3 - Concrete					
Cast-in-Place Concrete Subcont 6" S.O.G. 3'x3' thickened edge	ractor	1	allowance	36,000.00	36,000.00

Item Description	Qty	Unit	Unit Price	Extended Amount
	C	SI Division 3 -	36,000.00	
CSI Division 5 - Metals				
Aluminum canopy and structure Subcontractor Erected	4784	sf	42.00	200,928.00
		CSI Division 5	- Metals Total	200,928.00
CSI Division 8 - Openings				
Doors, Frames and Hardware Subcontractor New 3'0"x7'0" doors @ Aviation Lab	1	allowance	4,800.00	4,800.00
Doors, Frames and Hardware Subcontractor	3	each	1,600.00	4,800.00
	C	SI Division 8 - 0	Openings Total	9,600.00
CSI Division 9 - Finishes				
Plaster and Gypsum Board Subcontractor 2 hr rated wall allowance	136	lf	175.00	23,800.00
Flooring Subcontractor New VCT Classroom & Office areas	2380	sf	3.00	7,140.00
Flooring Subcontractor New vinyl base - Classroom and Office areas	250	lf	2.75	687.50
Ceilings Subcontractor Classroom and Office area	2380	sf	2.50	5,950.00
Painting and Coatings Subcontractor New paint Classroom, Office and rated walls	4000	sf	1.50	6,000.00
Floor Coatings Sealed concrete Aviation Lab floor	4000	sf	0.60	2,400.00
	(CSI Division 9 -	Finishes Total	45,977.50
CSI Division 11 - Equipment				
Equipment High volume ceiling fan for Aviation Lab	1	each	6,000.00	6,000.00
	CSI	Division 11 - Ed	quipment Total	6,000.00
CSI Division 22 - Plumbing				
Plumbing Subcontractor New eye wash & emergency shower	1	allowance	2,500.00	2,500.00
Plumbing Subcontractor New utility sink	1	allowance	2,000.00	2,000.00
Plumbing Subcontractor Parts washing with contaminated wash	1	allowance	5,000.00	5,000.00
	cs	I Division 22 - F	Plumbing Total	9,500.00
CSI Division 23 - HVAC				
HVAC Subcontractor Exhaust fan in welding area	1	allowance	2,500.00	2,500.00

Item	n Description	Qty	Unit	Unit Price	Extended Amount
	AC Subcontractor IVAC Classroom ductwork mods	1	allowance	5,500.00	5,500.00
			CSI Division 2	3 - HVAC Total	8,000.00
<u>CSI</u>	Division 26 - Electrical				
	etrical Subcontractor ncludes 600A service, all power, Fire Alarm, lighting, Data, Intercom a	1 nd B/A		180,000.00	180,000.00
		CS	I Division 26 -	Electrical Total	180,000.00
<u>CSI</u>	Division 32 - Exterior Improvements				
	ces and Gates lew chain link swing gates to Aviation Lab	1	allowance	8,000.00	8,000.00
	ces and Gates other fences and gates allowance	1	allowance	2,500.00	2,500.00
	CSI Division	n 32 -	- Exterior Impro	ovements Total	10,500.00
				Subtotal	576,621.56
Note	es			d Cost Subtotal	576,621.56 1,729.86
		Р		bility @ 0.30%	1,153.24
				Subtotal	579,504.66
			Over	head @ 0.00%	<u>0.00</u>
				Subtotal	579,504.66
			I	Fee @ 10.00%	<u>57,950.47</u>
				Subtotal	637,455.13
			_	Contingency	50,000.00
			Pre-const	truction/Design	<u>45,500.00</u>
			,	Subtotal	732,955.13
			1	Bond @ 1.10% Total	<u>8,062.51</u> 741,017.64
				iotai	141,011.04



Project No 1704601003 SBBC DB Eau Gallie Aircraft Maintenance Classroom Concept 3 Estimate Type: Estimate Status: Preliminary

Item Description	Qty	Unit	Unit Price	Extended Amount
CSI Division -				
		CSI	Division - Total	
CSI Division 0 - General Conditions				
Project Manager (PM)	174	hrs	63.19	10,995.06
PM Vehicle	1	months	800.00	800.00
PM Phone	1	months	70.00	70.00
Superintendent	400	hrs	53.93	21,572.00
Superintendent Vehicle	2.5	months	800.00	2,000.00
Superintendent Phone	2.5	months	70.00	175.00
Reproduction and printing	1	allowance	1,000.00	1,000.00
Dumpster	4	each	450.00	1,800.00
Daily and final cleanup	1	allowance	3,500.00	3,500.00
Protection of surrounding facilities	1	allowance	2,500.00	2,500.00
Temporary fencing	1	allowance	1,800.00	1,800.00
	CSI Division	ı 0 - General	Conditions Total	46,212.06
CSI Division 1 - General Requirements				
Engineering and testing	1	allowance	2,500.00	2,500.00
Utility locates	1	allowance	1,600.00	1,600.00
	CSI Division 1 -	General Red	quirements Total	4,100.00
CSI Division 2 - Existing Conditions				
Demolition Subcontractor Clearing and removal of asphalt paving	1	allowance	15,000.00	15,000.00
	CSI Division	n 2 - Existing	Conditions Total	15,000.00
CSI Division 3 - Concrete				
Cast-in-Place Concrete Subcontractor	1	allowance	62,500.00	62,500.00

62,500.00

CSI Division 3 - Concrete Total

6" S. O. G. with 3'x3' thickened edge

Item Description	Qty	Unit	Unit Price	Extended Amount
CSI Division 4 - Masonry				
Unit Masonry Subcontractor 125' each side Stem wall per concept #3	1	allowance	15,000.00	15,000.00
	C	CSI Division 4 -	Masonry Total	15,000.00
CSI Division 5 - Metals				
Pre-engineered metal building Includes insulated wall panels and header and jambs for bi-fold door	7500	sf	16.50	123,750.00
Metal building erection	7500	sf	7.50	56,250.00
		CSI Division 5	- Metals Total	180,000.00
CSI Division 8 - Openings				
Specialty Doors and Frames Subcontractor 40' Bi-fold lift hanger entry door	1	each	13,500.00	13,500.00
Doors, Frames and Hardware Subcontractor Exterior entry/exit single leaf doors with panic hardware	4	each	2,500.00	10,000.00
Doors, Frames and Hardware Subcontractor Interior classroom doors/frames/hardware installed	5	each	1,500.00	7,500.00
	C	SI Division 8 - C	penings Total	31,000.00
CSI Division 9 - Finishes				
Plaster and Gypsum Board Subcontractor Partition walls for Classroom, office and toilet rooms	240	lf	100.00	24,000.00
Ceilings Subcontractor Acoustical ceiling for classroom, office and toilet rooms	1800	sf	2.50	4,500.00
Flooring Subcontractor VCT in Office and Classroom	1650	sf	3.00	4,950.00
Flooring Subcontractor VCT Base in Office and Classroom	205	If	2.75	563.75
Flooring Subcontractor Ceramic tile for toilet room floors and wainscot	360	sf	10.00	3,600.00
Painting and Coatings Subcontractor Sealer for concrete floor in the Aviation Lab	5700	sf	0.60	3,420.00
Painting and Coatings Subcontractor Painting walls in Classroom, office and above wainscot in Toilet room	2750 ns	sf	1.50	4,125.00
	C	CSI Division 9 -	Finishes Total	45,158.75
CSI Division 10 - Specialties				
Toilet, Bath, and Laundry Accessories	1	allowance	1,000.00	1,000.00
	CSI	Division 10 - Sp	ecialties Total	1,000.00
CSI Division 11 - Equipment				
High volume ceiling fan for aviation lab Included in Electrical	1	0	0.00	0.00

Item Description	Qty	Unit	Unit Price	Extended Amount
	CSI	Division 11 -	Equipment Total	0.00
CSI Division 22 - Plumbing				
Plumbing Subcontractor Parts washing with containerized waste	1	allowance	5,000.00	5,000.00
Plumbing Subcontractor Eye wash and emergency shower	1	each	2,500.00	2,500.00
Plumbing Subcontractor Utility sink, drinking fountains, floor drains and plumbing fixtures for toi	1 let roon	allowance ns & compresse	23,500.00 d air outlet.	23,500.00
	cs	Division 22	- Plumbing Total	31,000.00
CSI Division 23 - HVAC				
HVAC Subcontractor 6 ton DX A/C system to serve classroom, office and toilet rooms	1	allowance	26,000.00	26,000.00
HVAC Subcontractor Exhaust fans for toilet rooms and ventilation @ welding station	1	allowance	3,500.00	3,500.00
		CSI Division	23 - HVAC Total	29,500.00
CSI Division 26 - Electrical				
Electrical Subcontractor 600A service, 4 floor boxes, power outlets and lighting allowance	1	allowance	130,000.00	130,000.00
	CS	l Division 26	- Electrical Total	130,000.00
CSI Division 28 - Electronic Safety and Security				
Fire Detection and Alarm Subcontractor (included in electrical)	1	0	0.00	0.00
CSI Division 28 - E	Electro	onic Safety ar	d Security Total	0.00
CSI Division 33 - Utilities				
Stormwater Utilities Site drainage mods and tie down spouts into site drainage system	1	allowance	15,000.00	15,000.00
Utilities Subcontractor Water & sewer to site of the work	1	allowance	25,000.00	25,000.00
	C	SI Division 3	3 - Utilities Total	40,000.00
			Subtotal	630,470.81
Notes	Ρ	General L rofessional L Ove	ed Cost Subtotal iability @ 0.30% iability @ 0.20% Subtotal erhead @ 0.00% Subtotal Fee @ 10.00% Subtotal Contingency struction/Design	630,470.81 1,891.41 1,260.94 633,623.16 0.00 633,623.16 63,362.32 696,985.48 50,000.00 58,900.00

Item Description	Qty Unit	Unit Price	Extended Amount
		0	005 005 40

 Subtotal
 805,885.48

 Bond @ 1.10%
 8.864.74

 Total
 814,750.22




Project No 1704601004 SBBC DB Eau Gallie Aircraft Maintenance Classroom Concept 4 Estimate Type: Estimate Status: Preliminary

Item Description	Qty	Unit	Unit Price	Extended Amount
CSI Division 0 - General Conditions				
Project Manager (PM)	174	hrs	63.19	10,995.06
PM Vehicle	1	months	800.00	800.00
PM Phone	1	months	70.00	70.00
Superintendent	2.5	months	53.19	132.98
Superintendent Vehicle	2.5	months	800.00	2,000.00
Superintendent Phone	2.5	months	70.00	175.00
Reproduction and Printing	1	allowance	1,000.00	1,000.00
Dumpster	4	each	450.00	1,800.00
Daily and final cleaning	1	allowance	3,500.00	3,500.00
Protection of surrounding facilities	1	allowance	2,500.00	2,500.00
Temporary fencing	1	allowance	1,800.00	1,800.00
	CSI Division	0 - General C	onditions Total	24,773.04
CSI Division 1 - General Requirements				
Engineering and Testing	1	allowance	2,500.00	2,500.00
Jtility Locates	1	allowance	1,600.00	1,600.00
	CSI Division 1 - General Requirements Total			4,100.00
CSI Division 2 - Existing Conditions				
Demolition Subcontractor Clearing and removal of asphalt paving	1	allowance	15,000.00	15,000.00
Demolition Subcontractor Remove existing flooring	2380	sf	0.55	1,309.00
Demolition Subcontractor Remove existing ceiling	2380	sf	0.35	833.00
	CSI Division	2 - Existing C	onditions Total	17,142.00
CSI Division 3 - Concrete				
Cast-in-Place Concrete Subcontractor 6" S.O.G. with 3'x3' thickened edge	1	allowance	62,500.00	62,500.00
	С	SI Division 3 -	Concrete Total	62,500.00

Item Description	Qty	Unit	Unit Price	Extended Amount
CSI Division 5 - Metals				
Pre-engineered metal building	7500	sf	11.00	82,500.00
Metal building erection	7500	sf	6.00	45,000.00
		CSI Division 5	- Metals Total	127,500.00
CSI Division 9 - Finishes				
Flooring Subcontractor New VCT flooring	2380	sf	3.00	7,140.00
Flooring Subcontractor New Vinyl base	250	If	2.75	687.50
Ceilings Subcontractor	2380	sf	2.50	5,950.00
Plaster and Gypsum Board Subcontractor	1	allowance	9,800.00	9,800.00
Painting and Coatings Subcontractor New paint classroom and office walls	1	allowance	3,900.00	3,900.00
Floor Coatings Sealed concrete Aviation Lab floor	7500	sf	0.60	4,500.00
	C	CSI Division 9 - I	Finishes Total	31,977.50
CSI Division 11 - Equipment				
Equipment High volume ceiling fan for Aviation Lab	1	allowance	6,000.00	6,000.00
	CSI	Division 11 - Eq	uipment Total	6,000.00
CSI Division 22 - Plumbing				
Plumbing Subcontractor New eye wash and emergency shower	1	each	2,500.00	2,500.00
Plumbing Subcontractor New utility sink	1	each	2,000.00	2,000.00
Plumbing Subcontractor Parts washing with contaminated waste	1	each	5,000.00	5,000.00
	CS	l Division 22 - P	lumbing Total	9,500.00
CSI Division 23 - HVAC				
HVAC Subcontractor HVAC allowance for classroom and office duct mods	1	allowance	3,500.00	3,500.00
		CSI Division 23	- HVAC Total	3,500.00
CSI Division 26 - Electrical				
Electrical Subcontractor 600A service, 4 floor boxes, power outlets, lighting, Data and Interco	1 om allowa	allowance nce	130,000.00	130,000.00
	CS	I Division 26 - E	lectrical Total	130,000.00

Item Description	Qty	Unit	Unit Price	Extended Amount
CSI Division 28 - Electronic Safety and S	<u>ecurity</u>			
Fire Detection and Alarm Subcontractor In Electrical	1	0	0.00	0.00
	CSI Division 28 - Electro	onic Safety an	d Security Total	0.00
CSI Division 32 - Exterior Improvements				
Fences and Gates Large swing gates and 3 personal access gate	1	allowance	11,500.00	11,500.00
Fences and Gates 4' chain link perimeter fencing	310	lf	12.00	3,720.00
	CSI Division 32 -	Exterior Imp	rovements Total	15,220.00
CSI Division 33 - Utilities				
Stormwater Utilities Site drainage mods and tie down spouts into si	1 re drainage system	allowance	15,000.00	15,000.00
Utilities Subcontractor Water and sewer to site of the work	1	allowance	25,000.00	25,000.00
	C	SI Division 3	3 - Utilities Total	40,000.00
			Subtotal	472,212.54
Notes		Estimate	ed Cost Subtotal	472,212.54
		General Liability @ 0.30%		1,416.64
	P	rofessional Li	<u>944.43</u>	
			Subtotal	474,573.61
		Ove	rhead @ 0.00%	<u>0.00</u>
			Subtotal	474,573.61
			Fee @ 10.00%	<u>47,457.36</u>
			Subtotal	522,030.97
		_	Contingency	50,000.00
		Pre-con:	struction/Design	<u>60,400.00</u>
			Subtotal	632,430.97
			Bond @ 1.10%	<u>6,956.74</u>

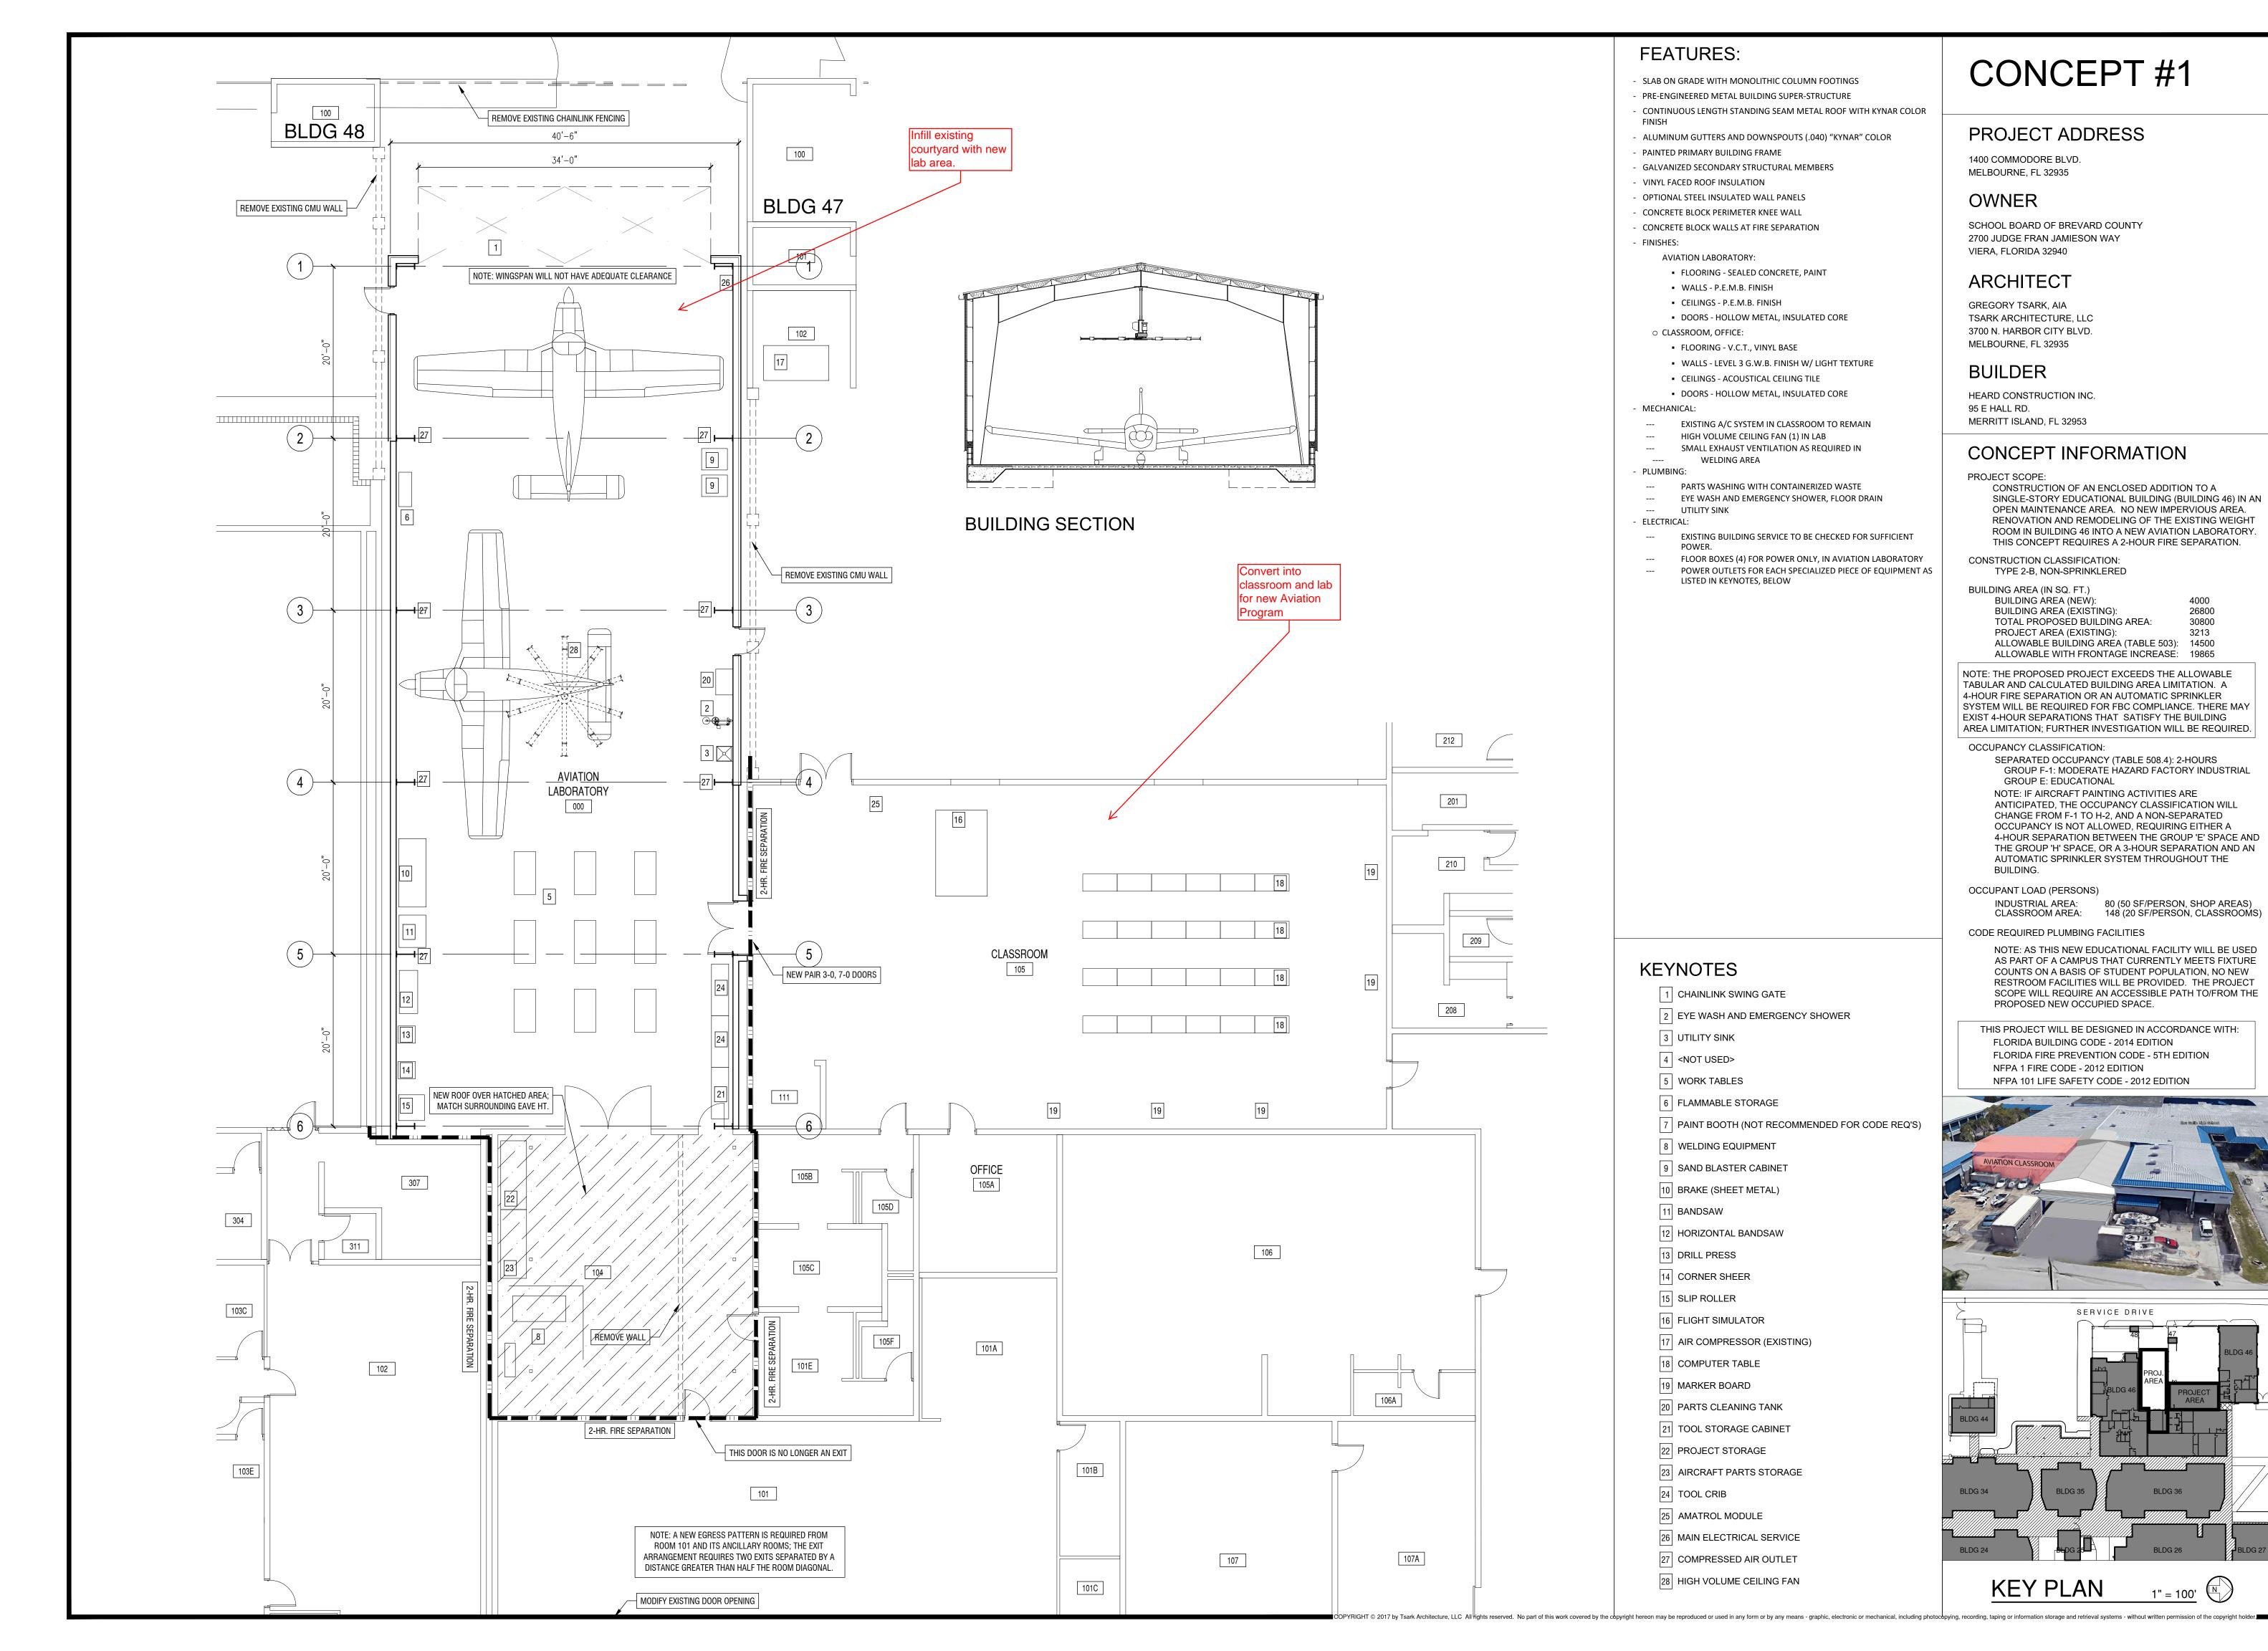

CONCEPT #1

PROJECT ADDRESS

1400 COMMODORE BLVD. MELBOURNE, FL 32935

OWNER

SCHOOL BOARD OF BREVARD COUNTY 2700 JUDGE FRAN JAMIESON WAY VIERA, FLORIDA 32940

ARCHITECT

GREGORY TSARK, AIA TSARK ARCHITECTURE, LLC 3700 N. HARBOR CITY BLVD. MELBOURNE, FL 32935

BUILDER

HEARD CONSTRUCTION INC. 95 E HALL RD. MERRITT ISLAND, FL 32953

CONCEPT INFORMATION

PROJECT SCOPE: CONSTRUCTION OF AN ENCLOSED ADDITION TO A SINGLE-STORY EDUCATIONAL BUILDING (BUILDING 46) IN AN OPEN MAINTENANCE AREA. NO NEW IMPERVIOUS AREA. RENOVATION AND REMODELING OF THE EXISTING WEIGHT ROOM IN BUILDING 46 INTO A NEW AVIATION LABORATORY. THIS CONCEPT REQUIRES A 2-HOUR FIRE SEPARATION.

CONSTRUCTION CLASSIFICATION: TYPE 2-B, NON-SPRINKLERED

BUILDING AREA (IN SQ. FT.) BUILDING ÀREA (NEW): 4000 **BUILDING AREA (EXISTING):** 26800 TOTAL PROPOSED BUILDING AREA: 30800 PROJECT AREA (EXISTING): ALLOWABLE BUILDING AREA (TABLE 503): 14500 ALLOWABLE WITH FRONTAGE INCREASE: 19865

NOTE: THE PROPOSED PROJECT EXCEEDS THE ALLOWABLE TABULAR AND CALCULATED BUILDING AREA LIMITATION. A 4-HOUR FIRE SEPARATION OR AN AUTOMATIC SPRINKLER SYSTEM WILL BE REQUIRED FOR FBC COMPLIANCE. THERE MAY EXIST 4-HOUR SEPARATIONS THAT SATISFY THE BUILDING AREA LIMITATION; FURTHER INVESTIGATION WILL BE REQUIRED.

OCCUPANCY CLASSIFICATION: SEPARATED OCCUPANCY (TABLE 508.4): 2-HOURS GROUP F-1: MODERATE HAZARD FACTORY INDUSTRIAL GROUP E: EDUCATIONAL NOTE: IF AIRCRAFT PAINTING ACTIVITIES ARE ANTICIPATED, THE OCCUPANCY CLASSIFICATION WILL CHANGE FROM F-1 TO H-2, AND A NON-SEPARATED OCCUPANCY IS NOT ALLOWED, REQUIRING EITHER A 4-HOUR SEPARATION BETWEEN THE GROUP 'E' SPACE AND THE GROUP 'H' SPACE, OR A 3-HOUR SEPARATION AND AN

AUTOMATIC SPRINKLER SYSTEM THROUGHOUT THE

BUILDING. OCCUPANT LOAD (PERSONS)


INDUSTRIAL AREA: 80 (50 SF/PERSON, SHOP AREAS) CLASSROOM AREA: 148 (20 SF/PERSON, CLASSROOMS

CODE REQUIRED PLUMBING FACILITIES

NOTE: AS THIS NEW EDUCATIONAL FACILITY WILL BE USED AS PART OF A CAMPUS THAT CURRENTLY MEETS FIXTURE COUNTS ON A BASIS OF STUDENT POPULATION, NO NEW RESTROOM FACILITIES WILL BE PROVIDED. THE PROJECT SCOPE WILL REQUIRE AN ACCESSIBLE PATH TO/FROM THE PROPOSED NEW OCCUPIED SPACE.

THIS PROJECT WILL BE DESIGNED IN ACCORDANCE WITH: FLORIDA BUILDING CODE - 2014 EDITION FLORIDA FIRE PREVENTION CODE - 5TH EDITION NFPA 1 FIRE CODE - 2012 EDITION NFPA 101 LIFE SAFETY CODE - 2012 EDITION



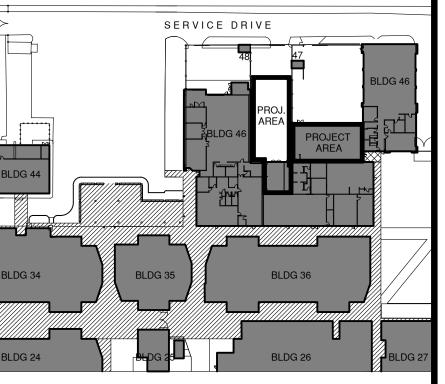

1" = 100'

KEY PLAN



Tsark Architecture, LLC 3700 N. Harbor City Blvd., Suite 2A Melbourne, Florida 32935

SHEET TITLE:


DRAWN BY:

REVISION:

4/23/2017

GIT

CONCEPT #1

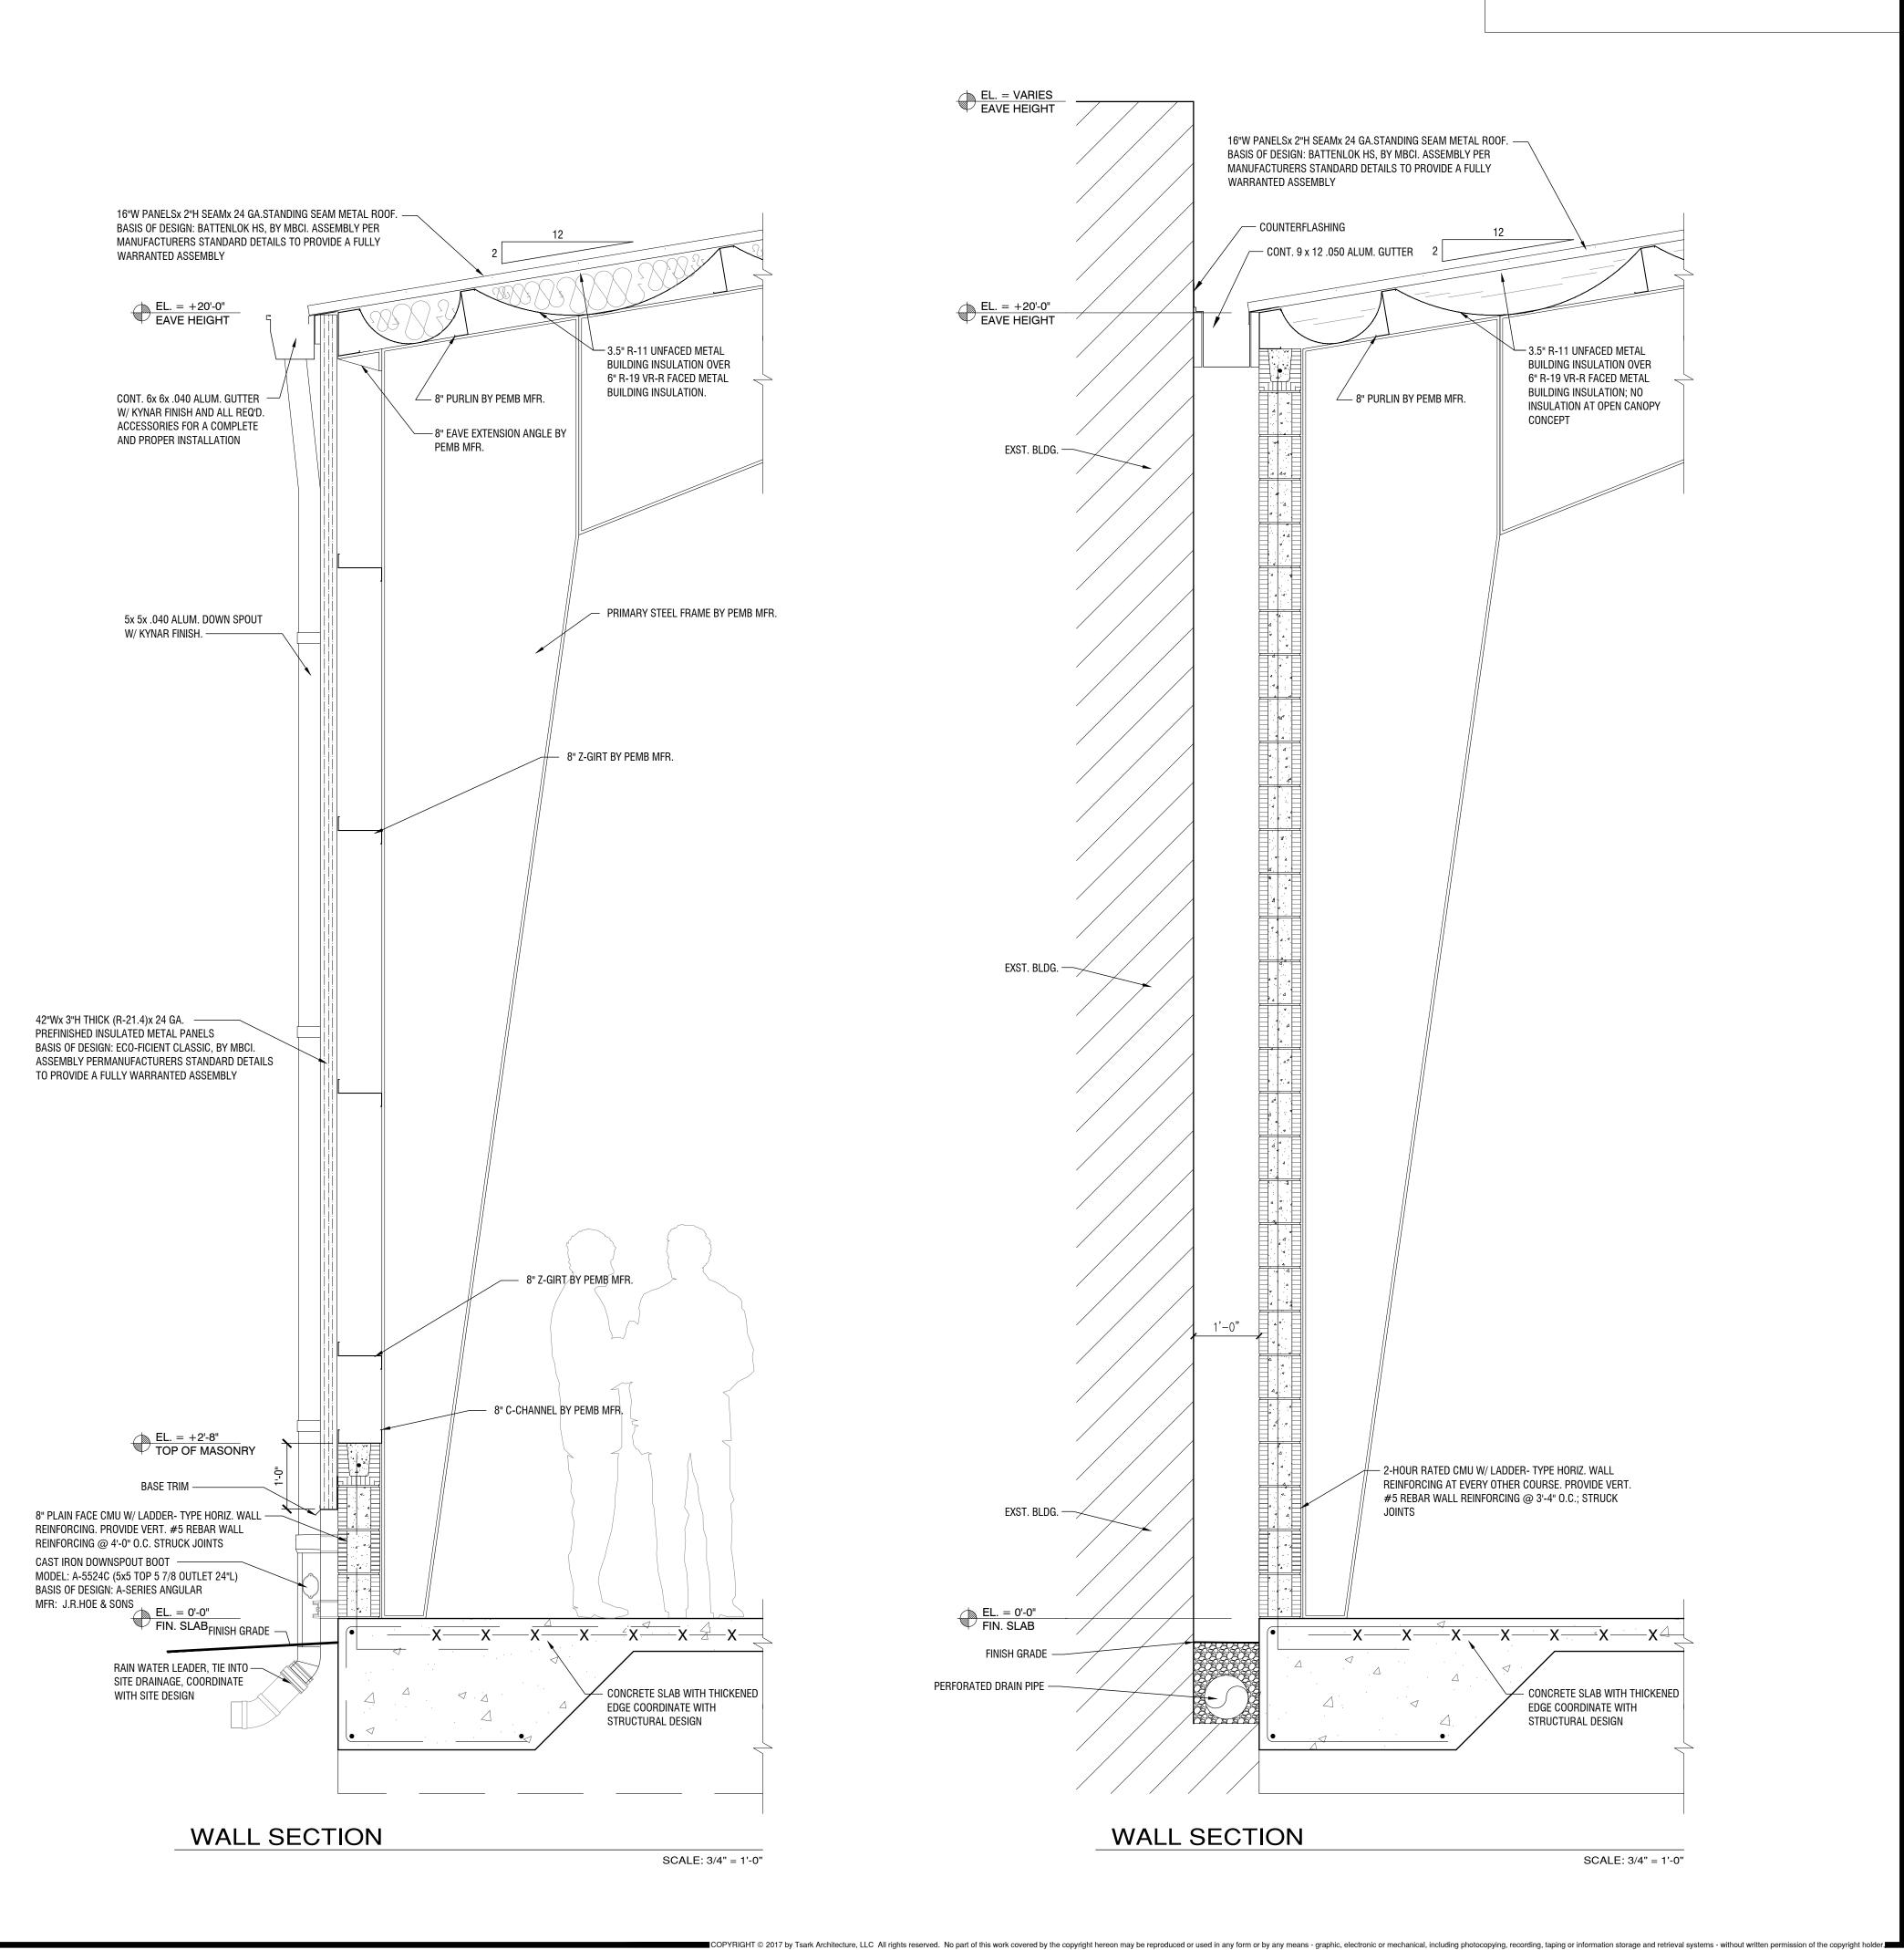



Tsark Architecture, LLC 3700 N. Harbor City Blvd., Suite 2A Melbourne, Florida 32935

Eau Gaille High School CIE Lab Brevard Public Schools


DATE: 4/23/2017
DRAWN BY: GIT

DRAWN BY:

REVISION:

1.



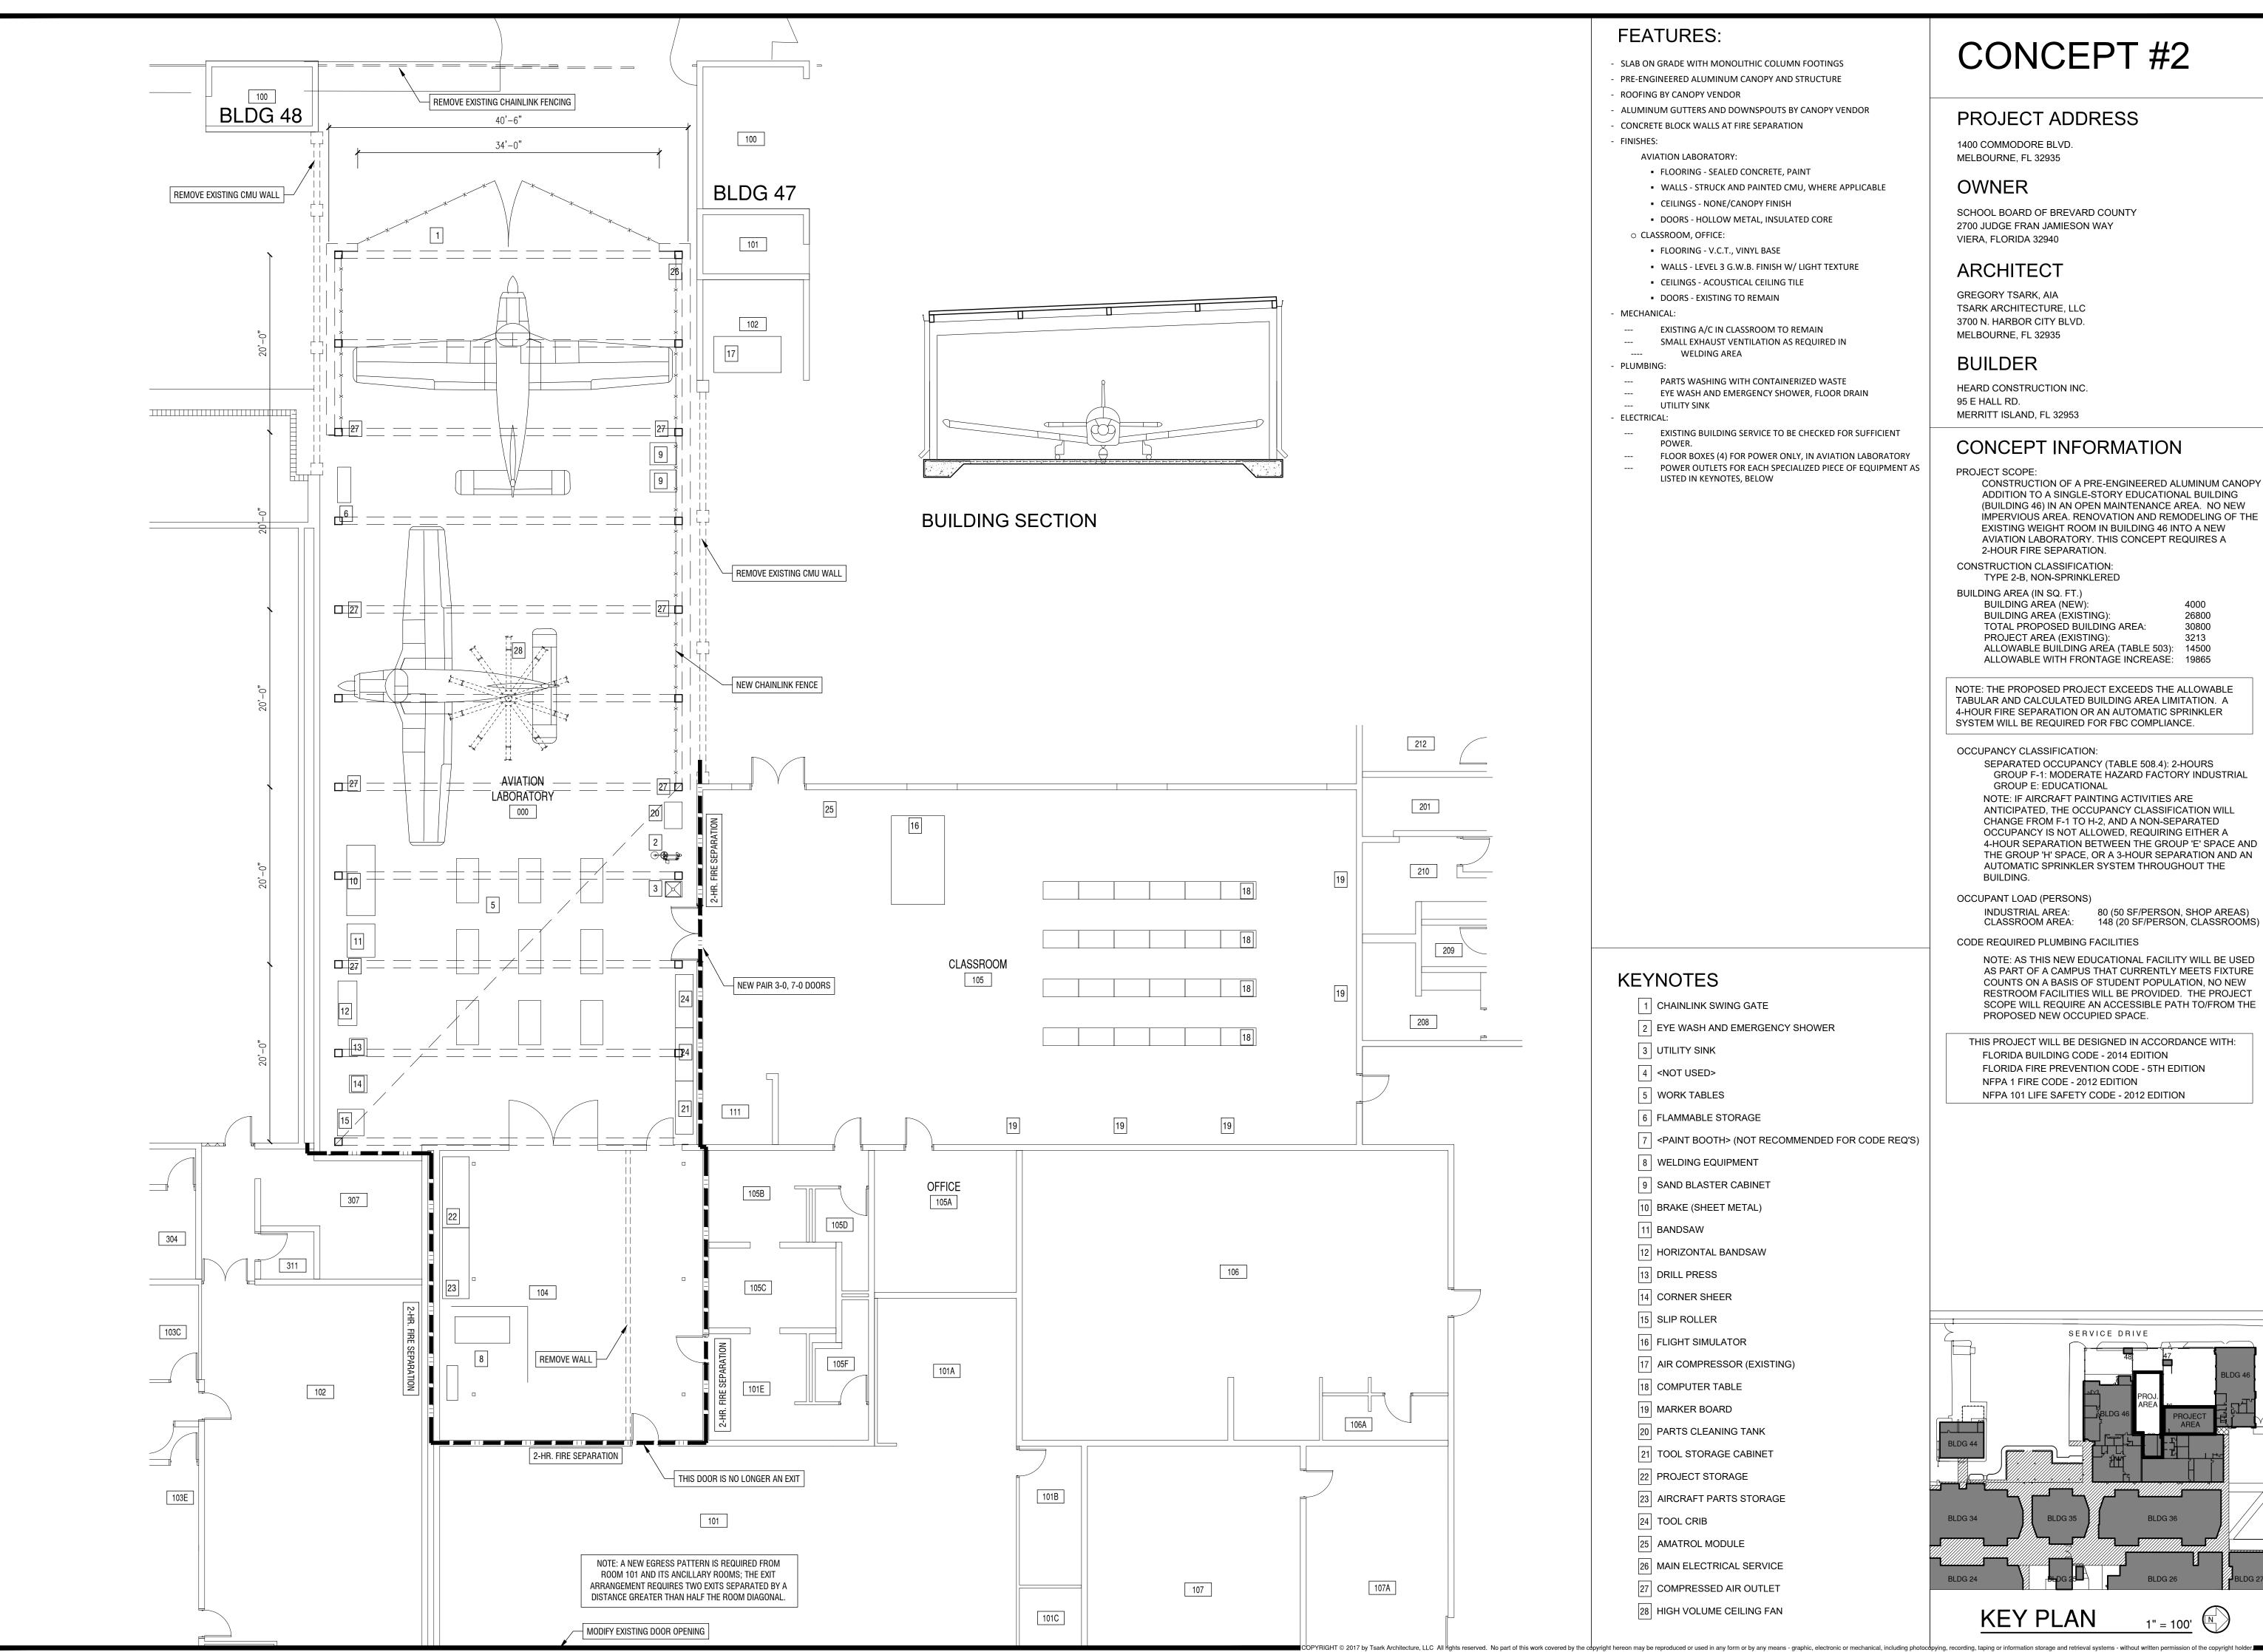

FEATURES:

- SLAB ON GRADE WITH MONOLITHIC COLUMN FOOTINGS
- PRE-ENGINEERED ALUMINUM CANOPY AND STRUCTURE
- ALUMINUM GUTTERS AND DOWNSPOUTS BY CANOPY VENDOR
- CONCRETE BLOCK WALLS AT FIRE SEPARATION
- FINISHES:
 - AVIATION LABORATORY:

ROOFING BY CANOPY VENDOR

- FLOORING SEALED CONCRETE, PAINT
- WALLS STRUCK AND PAINTED CMU, WHERE APPLICABLE
- CEILINGS NONE/CANOPY FINISH
- DOORS HOLLOW METAL, INSULATED CORE
- O CLASSROOM, OFFICE:
- FLOORING V.C.T., VINYL BASE
- WALLS LEVEL 3 G.W.B. FINISH W/ LIGHT TEXTURE
- CEILINGS ACOUSTICAL CEILING TILE
- DOORS EXISTING TO REMAIN MECHANICAL:
 - EXISTING A/C IN CLASSROOM TO REMAIN SMALL EXHAUST VENTILATION AS REQUIRED IN
 - WELDING AREA

- PLUMBING: PARTS WASHING WITH CONTAINERIZED WASTE

- EYE WASH AND EMERGENCY SHOWER, FLOOR DRAIN UTILITY SINK
- ELECTRICAL:

KEYNOTES

3 UTILITY SINK

4 <NOT USED>

5 WORK TABLES

6 FLAMMABLE STORAGE

8 WELDING EQUIPMENT

9 SAND BLASTER CABINET

10 BRAKE (SHEET METAL)

|12| HORIZONTAL BANDSAW

11 BANDSAW

13 DRILL PRESS

15 SLIP ROLLER

14 CORNER SHEER

16 FLIGHT SIMULATOR

18 COMPUTER TABLE

19 MARKER BOARD

20 PARTS CLEANING TANK

21 TOOL STORAGE CABINET

23 AIRCRAFT PARTS STORAGE

26 MAIN ELECTRICAL SERVICE

27 COMPRESSED AIR OUTLET

28 HIGH VOLUME CEILING FAN

22 PROJECT STORAGE

25 AMATROL MODULE

24 TOOL CRIB

| 17 | AIR COMPRESSOR (EXISTING)

1 CHAINLINK SWING GATE

2 EYE WASH AND EMERGENCY SHOWER

| 7 | <PAINT BOOTH> (NOT RECOMMENDED FOR CODE REQ'S)

- EXISTING BUILDING SERVICE TO BE CHECKED FOR SUFFICIENT
- FLOOR BOXES (4) FOR POWER ONLY, IN AVIATION LABORATORY POWER OUTLETS FOR EACH SPECIALIZED PIECE OF EQUIPMENT AS LISTED IN KEYNOTES, BELOW

CONCEPT #2

PROJECT ADDRESS

1400 COMMODORE BLVD. MELBOURNE, FL 32935

OWNER

SCHOOL BOARD OF BREVARD COUNTY 2700 JUDGE FRAN JAMIESON WAY VIERA, FLORIDA 32940

ARCHITECT

GREGORY TSARK, AIA TSARK ARCHITECTURE, LLC 3700 N. HARBOR CITY BLVD. MELBOURNE, FL 32935

BUILDER

HEARD CONSTRUCTION INC. 95 E HALL RD. MERRITT ISLAND, FL 32953

CONCEPT INFORMATION

PROJECT SCOPE:

CONSTRUCTION OF A PRE-ENGINEERED ALUMINUM CANOPY ADDITION TO A SINGLE-STORY EDUCATIONAL BUILDING (BUILDING 46) IN AN OPEN MAINTENANCE AREA. NO NEW IMPERVIOUS AREA. RENOVATION AND REMODELING OF THE EXISTING WEIGHT ROOM IN BUILDING 46 INTO A NEW AVIATION LABORATORY, THIS CONCEPT REQUIRES A 2-HOUR FIRE SEPARATION.

CONSTRUCTION CLASSIFICATION: TYPE 2-B, NON-SPRINKLERED

BUILDING AREA (IN SQ. FT.) BUILDING AREA (NEW):

4000 **BUILDING AREA (EXISTING):** 26800

TOTAL PROPOSED BUILDING AREA: 30800 PROJECT AREA (EXISTING): 3213

ALLOWABLE BUILDING AREA (TABLE 503): 14500 ALLOWABLE WITH FRONTAGE INCREASE: 19865

NOTE: THE PROPOSED PROJECT EXCEEDS THE ALLOWABLE TABULAR AND CALCULATED BUILDING AREA LIMITATION. A 4-HOUR FIRE SEPARATION OR AN AUTOMATIC SPRINKLER SYSTEM WILL BE REQUIRED FOR FBC COMPLIANCE.

OCCUPANCY CLASSIFICATION:

SEPARATED OCCUPANCY (TABLE 508.4): 2-HOURS GROUP F-1: MODERATE HAZARD FACTORY INDUSTRIAL GROUP E: EDUCATIONAL

NOTE: IF AIRCRAFT PAINTING ACTIVITIES ARE ANTICIPATED, THE OCCUPANCY CLASSIFICATION WILL

CHANGE FROM F-1 TO H-2, AND A NON-SEPARATED OCCUPANCY IS NOT ALLOWED, REQUIRING EITHER A 4-HOUR SEPARATION BETWEEN THE GROUP 'E' SPACE AND THE GROUP 'H' SPACE, OR A 3-HOUR SEPARATION AND AN AUTOMATIC SPRINKLER SYSTEM THROUGHOUT THE

BUILDING. OCCUPANT LOAD (PERSONS)

INDUSTRIAL AREA: 80 (50 SF/PERSON, SHOP AREAS) CLASSROOM AREA: 148 (20 SF/PERSON, CLASSROOMS

CODE REQUIRED PLUMBING FACILITIES

NOTE: AS THIS NEW EDUCATIONAL FACILITY WILL BE USED AS PART OF A CAMPUS THAT CURRENTLY MEETS FIXTURE COUNTS ON A BASIS OF STUDENT POPULATION, NO NEW RESTROOM FACILITIES WILL BE PROVIDED. THE PROJECT SCOPE WILL REQUIRE AN ACCESSIBLE PATH TO/FROM THE PROPOSED NEW OCCUPIED SPACE.

THIS PROJECT WILL BE DESIGNED IN ACCORDANCE WITH: FLORIDA BUILDING CODE - 2014 EDITION FLORIDA FIRE PREVENTION CODE - 5TH EDITION NFPA 1 FIRE CODE - 2012 EDITION

SERVICE DRIVE

1" = 100'

KEY PLAN

NFPA 101 LIFE SAFETY CODE - 2012 EDITION

SHEET TITLE:

Publi

ARCHITECTURE

Tsark Architecture, LLC

3700 N. Harbor City Blvd., Suite 2A

Melbourne, Florida 32935


DRAWN BY:

4/23/2017

GIT

REVISION:



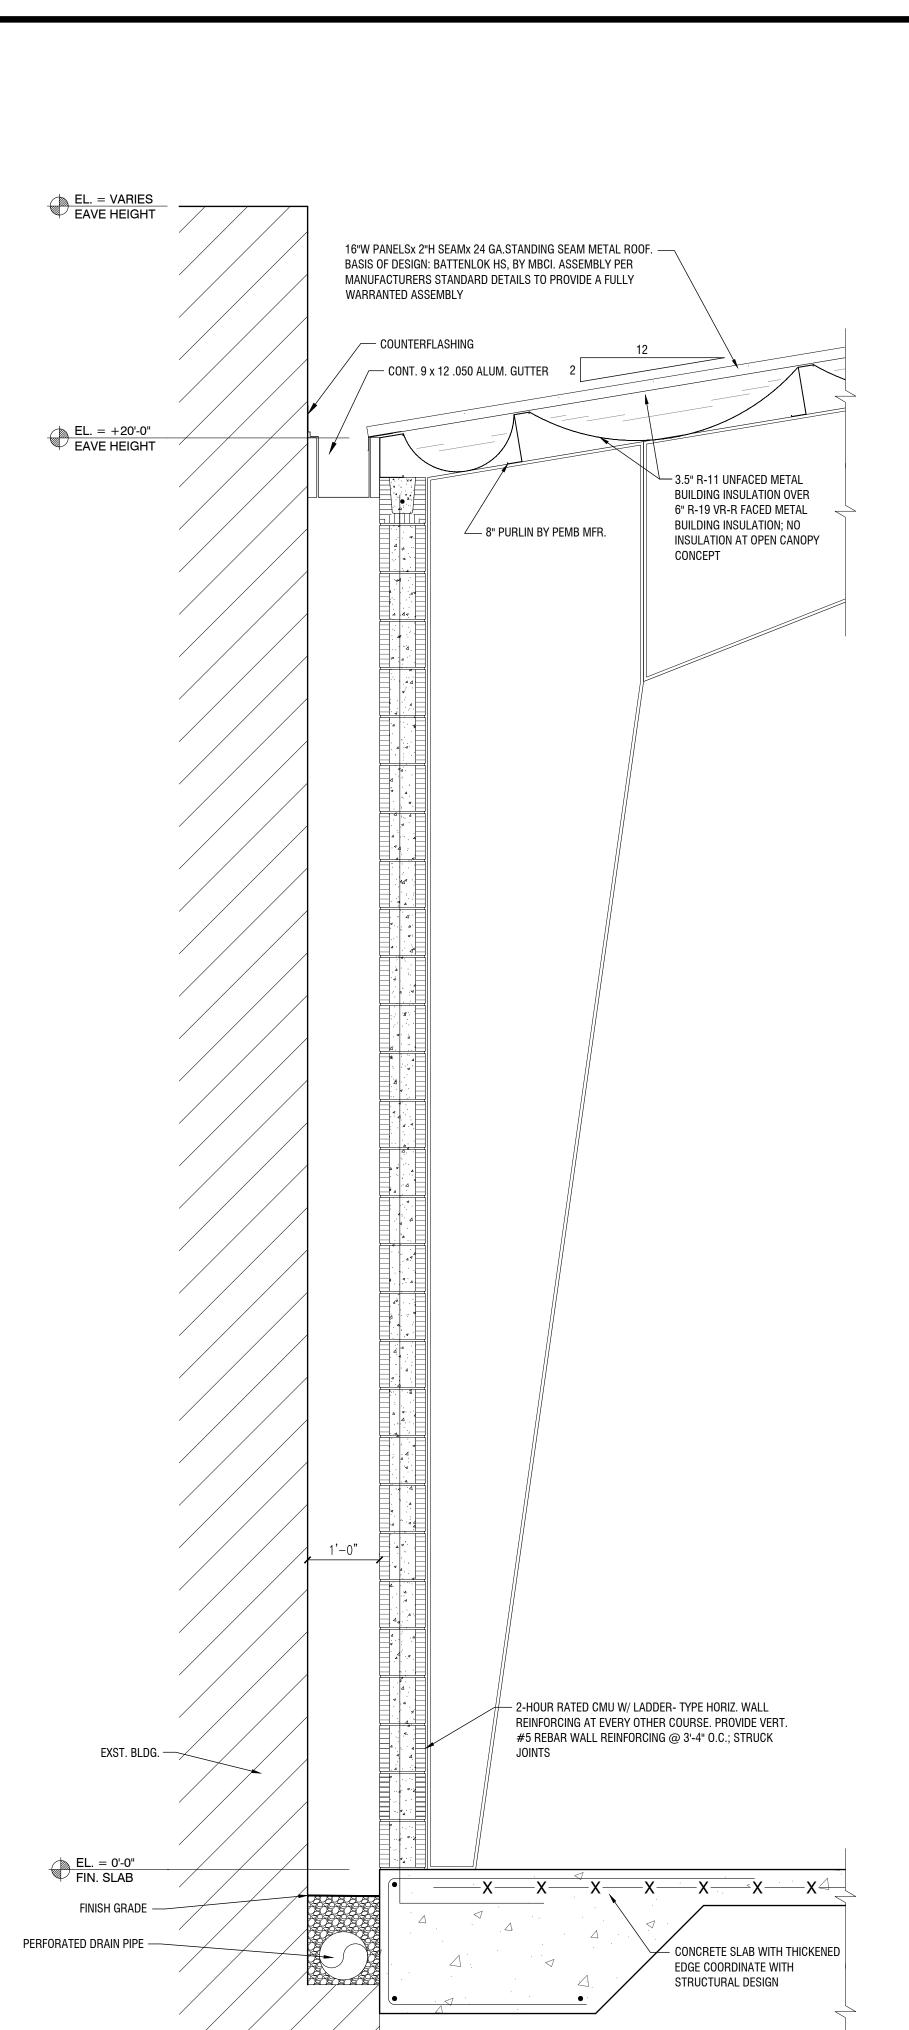

WALL SECTION

SCALE: 3/4" = 1'-0"

COPYRIGHT © 2017 by Tsark Architecture, LLC All rights reserved. No part of this work covered by the copyright hereon may be reproduced or used in any form or by any means - graphic, electronic or mechanical, including photocopying, recording, taping or information storage and retrieval systems - without written permission of the copyright holder.



Tsark Architecture, LLC 3700 N. Harbor City Blvd., Suite 2A Melbourne, Florida 32935


Eau Gallie High School CIE Lab Brevard Public Schools

2.

DRAWN BY: REVISION: 4/23/2017

GIT



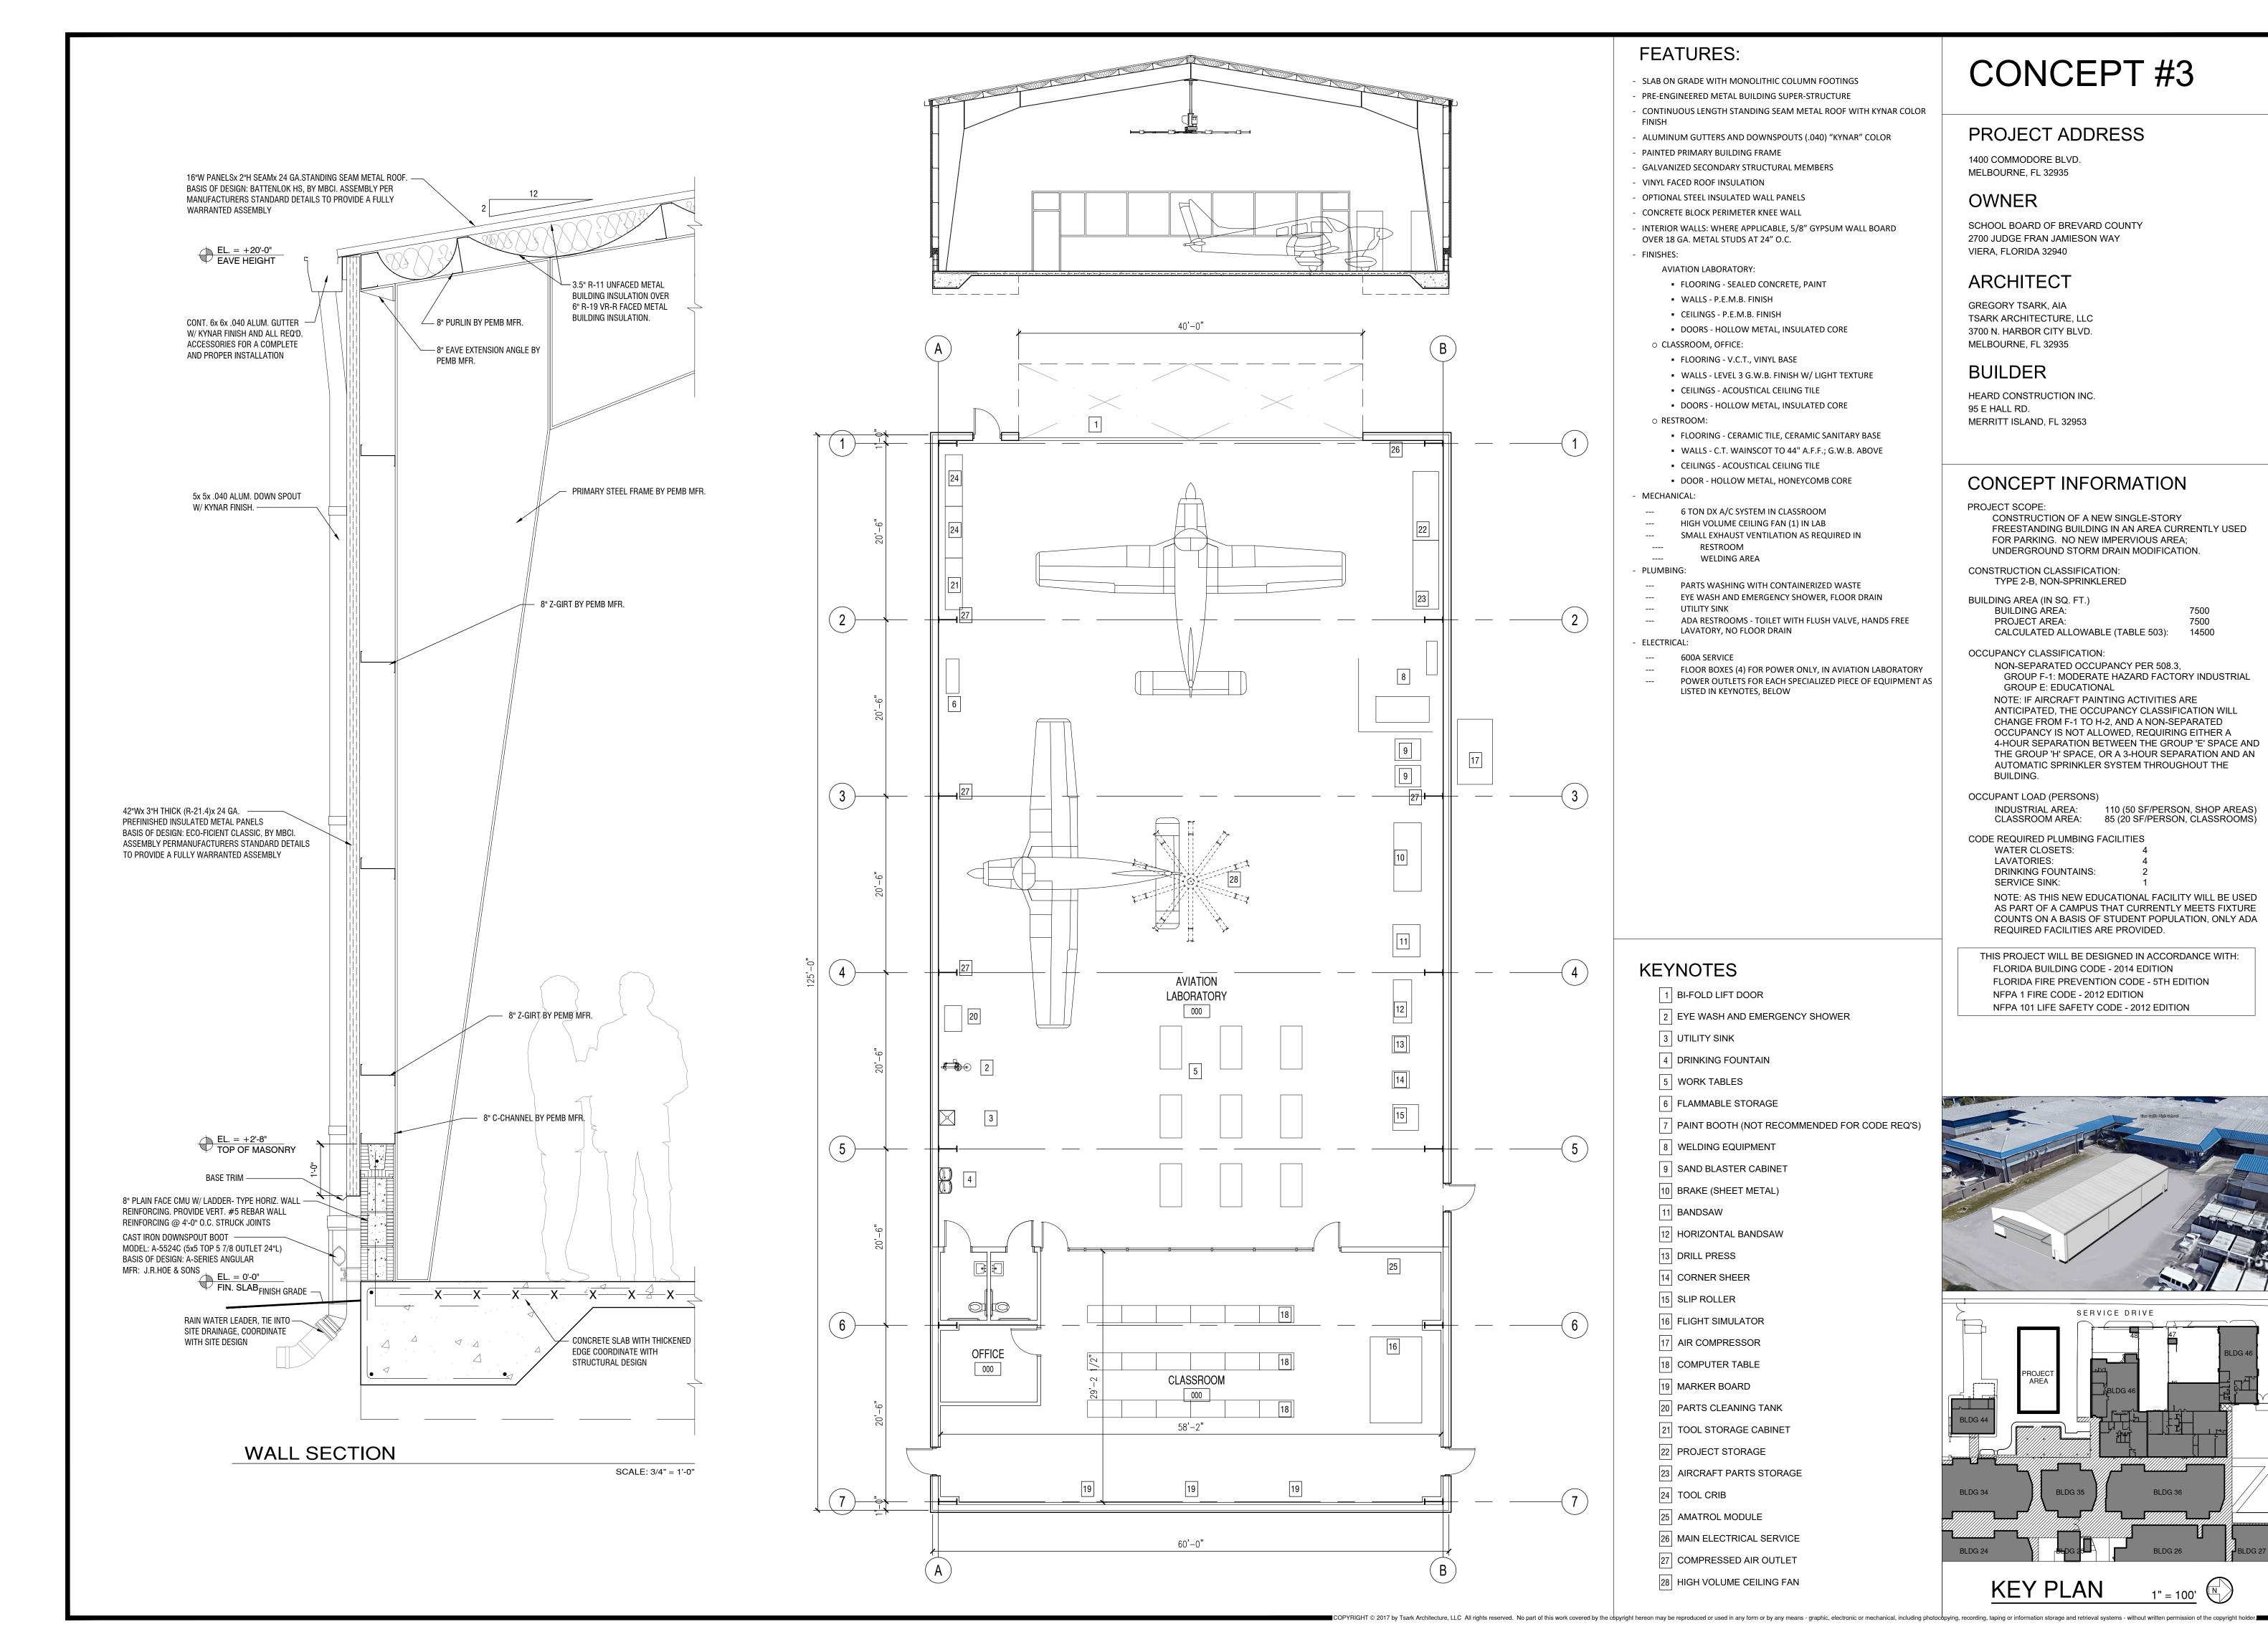

CONCEPT #3

PROJECT ADDRESS

1400 COMMODORE BLVD. MELBOURNE, FL 32935

OWNER

SCHOOL BOARD OF BREVARD COUNTY 2700 JUDGE FRAN JAMIESON WAY VIERA, FLORIDA 32940

ARCHITECT

GREGORY TSARK, AIA TSARK ARCHITECTURE, LLC 3700 N. HARBOR CITY BLVD. MELBOURNE, FL 32935

BUILDER

HEARD CONSTRUCTION INC. 95 E HALL RD. MERRITT ISLAND, FL 32953

CONCEPT INFORMATION

PROJECT SCOPE:

CONSTRUCTION OF A NEW SINGLE-STORY FREESTANDING BUILDING IN AN AREA CURRENTLY USED FOR PARKING. NO NEW IMPERVIOUS AREA; UNDERGROUND STORM DRAIN MODIFICATION.

CONSTRUCTION CLASSIFICATION: TYPE 2-B, NON-SPRINKLERED

BUILDING AREA (IN SQ. FT.) BUILDING AREA: PROJECT AREA:

CALCULATED ALLOWABLE (TABLE 503): 14500

OCCUPANCY CLASSIFICATION: NON-SEPARATED OCCUPANCY PER 508.3,

> GROUP F-1: MODERATE HAZARD FACTORY INDUSTRIAL GROUP E: EDUCATIONAL NOTE: IF AIRCRAFT PAINTING ACTIVITIES ARE ANTICIPATED, THE OCCUPANCY CLASSIFICATION WILL CHANGE FROM F-1 TO H-2, AND A NON-SEPARATED OCCUPANCY IS NOT ALLOWED, REQUIRING EITHER A 4-HOUR SEPARATION BETWEEN THE GROUP 'E' SPACE AND THE GROUP 'H' SPACE, OR A 3-HOUR SEPARATION AND AN

AUTOMATIC SPRINKLER SYSTEM THROUGHOUT THE BUILDING. OCCUPANT LOAD (PERSONS)

INDUSTRIAL AREA: 110 (50 SF/PERSON, SHOP AREAS) 85 (20 SF/PERSON, CLASSROOMS) CLASSROOM AREA:


CODE REQUIRED PLUMBING FACILITIES WATER CLOSETS: LAVATORIES: DRINKING FOUNTAINS:

SERVICE SINK: NOTE: AS THIS NEW EDUCATIONAL FACILITY WILL BE USED AS PART OF A CAMPUS THAT CURRENTLY MEETS FIXTURE COUNTS ON A BASIS OF STUDENT POPULATION, ONLY ADA REQUIRED FACILITIES ARE PROVIDED.

THIS PROJECT WILL BE DESIGNED IN ACCORDANCE WITH: FLORIDA BUILDING CODE - 2014 EDITION FLORIDA FIRE PREVENTION CODE - 5TH EDITION NFPA 1 FIRE CODE - 2012 EDITION

NFPA 101 LIFE SAFETY CODE - 2012 EDITION



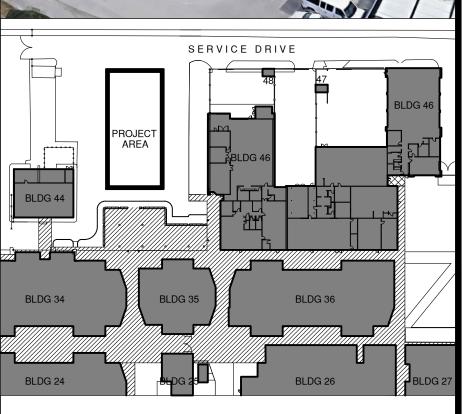

1" = 100'

KEY PLAN




Tsark Architecture, LLC 3700 N. Harbor City Blvd., Suite 2A Melbourne, Florida 32935

SHEET TITLE 4/23/2017 GIT DRAWN BY:

REVISION:



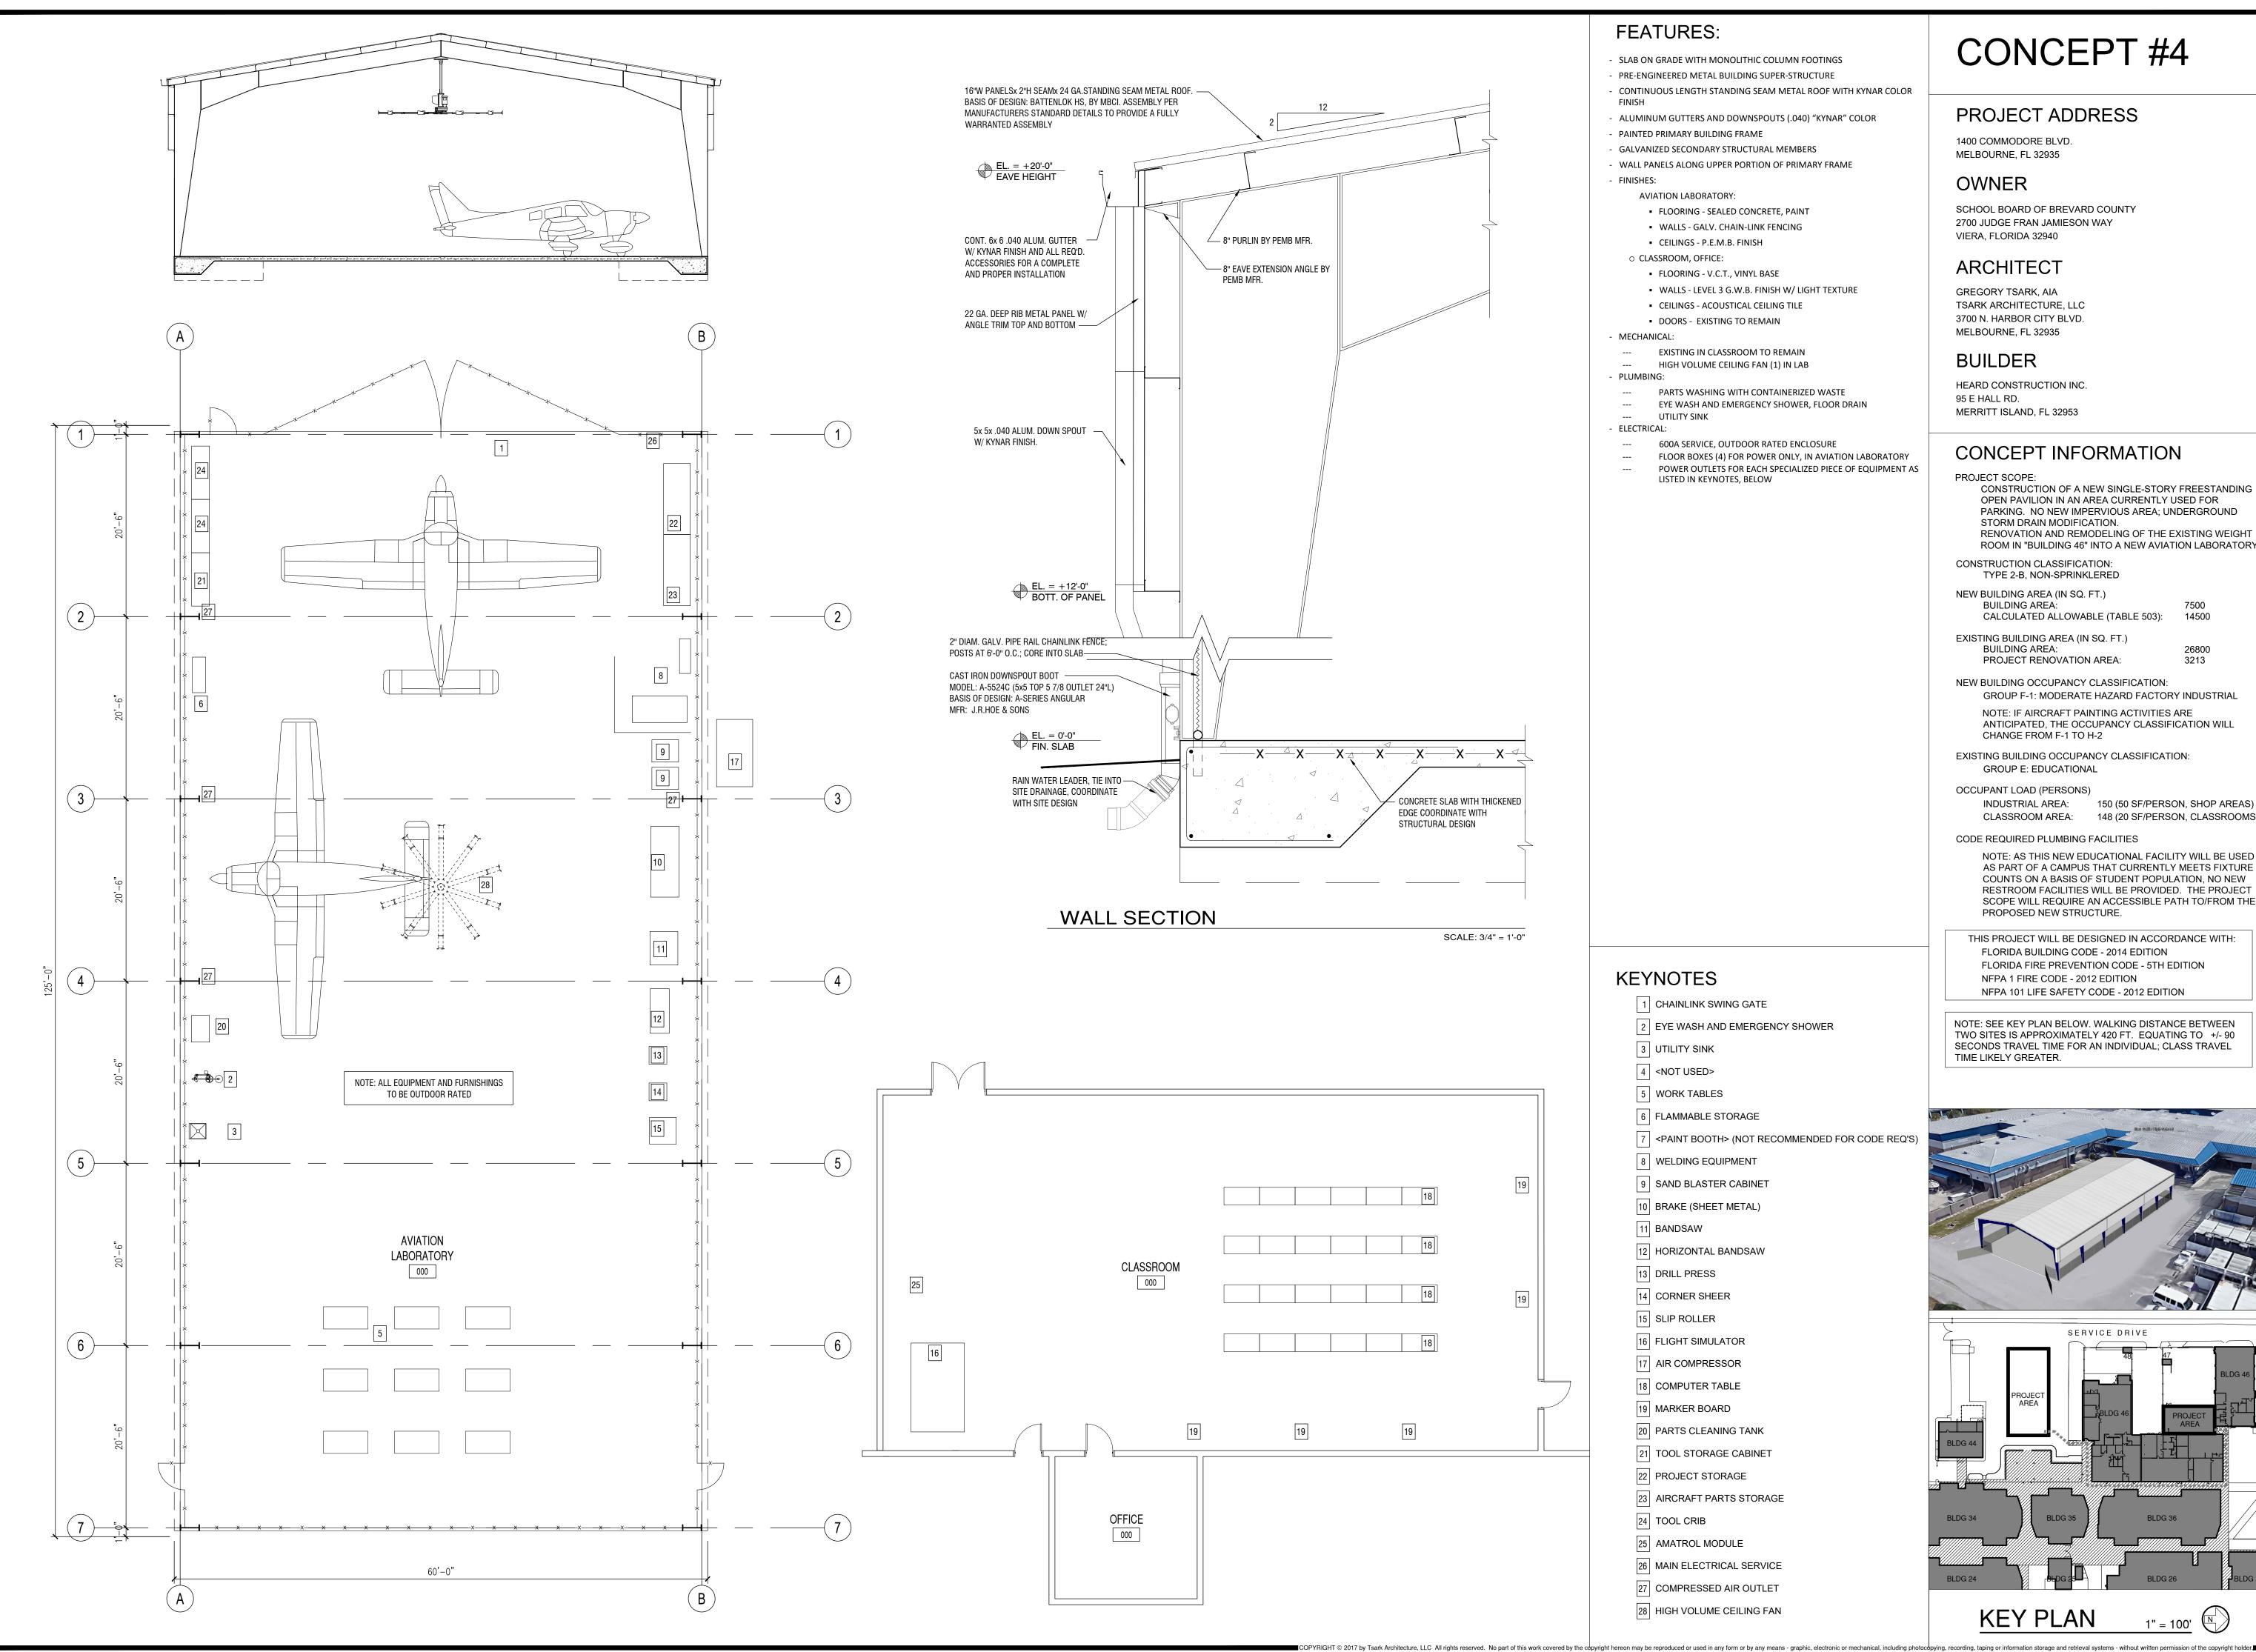

FEATURES:

- SLAB ON GRADE WITH MONOLITHIC COLUMN FOOTINGS
- PRE-ENGINEERED METAL BUILDING SUPER-STRUCTURE CONTINUOUS LENGTH STANDING SEAM METAL ROOF WITH KYNAR COLOR
- ALUMINUM GUTTERS AND DOWNSPOUTS (.040) "KYNAR" COLOR PAINTED PRIMARY BUILDING FRAME
- GALVANIZED SECONDARY STRUCTURAL MEMBERS
- WALL PANELS ALONG UPPER PORTION OF PRIMARY FRAME

AVIATION LABORATORY:

- FLOORING SEALED CONCRETE, PAINT
- WALLS GALV. CHAIN-LINK FENCING
- CEILINGS P.E.M.B. FINISH
- O CLASSROOM, OFFICE:
- FLOORING V.C.T., VINYL BASE
- WALLS LEVEL 3 G.W.B. FINISH W/ LIGHT TEXTURE
- CEILINGS ACOUSTICAL CEILING TILE

MECHANICAL:

EXISTING IN CLASSROOM TO REMAIN HIGH VOLUME CEILING FAN (1) IN LAB

DOORS - EXISTING TO REMAIN

- PLUMBING:
 - PARTS WASHING WITH CONTAINERIZED WASTE EYE WASH AND EMERGENCY SHOWER, FLOOR DRAIN UTILITY SINK

2 EYE WASH AND EMERGENCY SHOWER

3 UTILITY SINK

4 <NOT USED>

5 WORK TABLES

6 FLAMMABLE STORAGE

8 WELDING EQUIPMENT

9 SAND BLASTER CABINET

10 BRAKE (SHEET METAL)

|12| HORIZONTAL BANDSAW

11 BANDSAW

13 DRILL PRESS

15 SLIP ROLLER

14 CORNER SHEER

16 FLIGHT SIMULATOR

| 17 | AIR COMPRESSOR

18 COMPUTER TABLE

19 MARKER BOARD

20 PARTS CLEANING TANK

21 TOOL STORAGE CABINET

23 AIRCRAFT PARTS STORAGE

26 MAIN ELECTRICAL SERVICE

27 COMPRESSED AIR OUTLET

28 HIGH VOLUME CEILING FAN

22 PROJECT STORAGE

25 AMATROL MODULE

24 TOOL CRIB

POWER OUTLETS FOR EACH SPECIALIZED PIECE OF EQUIPMENT AS

600A SERVICE, OUTDOOR RATED ENCLOSURE

- FLOOR BOXES (4) FOR POWER ONLY, IN AVIATION LABORATORY
- LISTED IN KEYNOTES, BELOW

CONCEPT #4

PROJECT ADDRESS

1400 COMMODORE BLVD. MELBOURNE, FL 32935

OWNER

SCHOOL BOARD OF BREVARD COUNTY 2700 JUDGE FRAN JAMIESON WAY VIERA, FLORIDA 32940

ARCHITECT

GREGORY TSARK, AIA TSARK ARCHITECTURE, LLC 3700 N. HARBOR CITY BLVD. MELBOURNE, FL 32935

BUILDER

HEARD CONSTRUCTION INC. 95 E HALL RD. MERRITT ISLAND, FL 32953

CONCEPT INFORMATION

CONSTRUCTION OF A NEW SINGLE-STORY FREESTANDING OPEN PAVILION IN AN AREA CURRENTLY USED FOR PARKING. NO NEW IMPERVIOUS AREA; UNDERGROUND STORM DRAIN MODIFICATION. RENOVATION AND REMODELING OF THE EXISTING WEIGHT ROOM IN "BUILDING 46" INTO A NEW AVIATION LABORATORY

CONSTRUCTION CLASSIFICATION: TYPE 2-B, NON-SPRINKLERED

BUILDING AREA:

NEW BUILDING AREA (IN SQ. FT.) BUILDING AREA: CALCULATED ALLOWABLE (TABLE 503):

EXISTING BUILDING AREA (IN SQ. FT.)

PROJECT RENOVATION AREA:

NEW BUILDING OCCUPANCY CLASSIFICATION:

14500

26800

3213

GROUP F-1: MODERATE HAZARD FACTORY INDUSTRIAL NOTE: IF AIRCRAFT PAINTING ACTIVITIES ARE ANTICIPATED, THE OCCUPANCY CLASSIFICATION WILL CHANGE FROM F-1 TO H-2

EXISTING BUILDING OCCUPANCY CLASSIFICATION: GROUP E: EDUCATIONAL

OCCUPANT LOAD (PERSONS)

INDUSTRIAL AREA: 150 (50 SF/PERSON, SHOP AREAS) CLASSROOM AREA: 148 (20 SF/PERSON, CLASSROOMS)


CODE REQUIRED PLUMBING FACILITIES

NOTE: AS THIS NEW EDUCATIONAL FACILITY WILL BE USED COUNTS ON A BASIS OF STUDENT POPULATION, NO NEW RESTROOM FACILITIES WILL BE PROVIDED. THE PROJECT SCOPE WILL REQUIRE AN ACCESSIBLE PATH TO/FROM THE PROPOSED NEW STRUCTURE.

THIS PROJECT WILL BE DESIGNED IN ACCORDANCE WITH: FLORIDA BUILDING CODE - 2014 EDITION FLORIDA FIRE PREVENTION CODE - 5TH EDITION NFPA 1 FIRE CODE - 2012 EDITION NFPA 101 LIFE SAFETY CODE - 2012 EDITION

NOTE: SEE KEY PLAN BELOW. WALKING DISTANCE BETWEEN TWO SITES IS APPROXIMATELY 420 FT. EQUATING TO +/- 90 SECONDS TRAVEL TIME FOR AN INDIVIDUAL; CLASS TRAVEL TIME LIKELY GREATER.



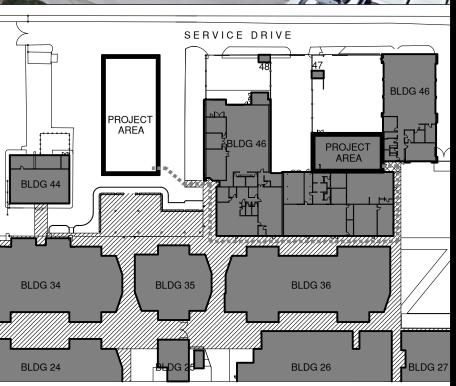

KEY PLAN

1" = 100'

ARCHITECTURE

Tsark Architecture, LLC

3700 N. Harbor City Blvd., Suite 2A

Melbourne, Florida 32935

4/23/2017

GIT

SHEET TITLE:

DRAWN BY:

REVISION:

